



Cardiff

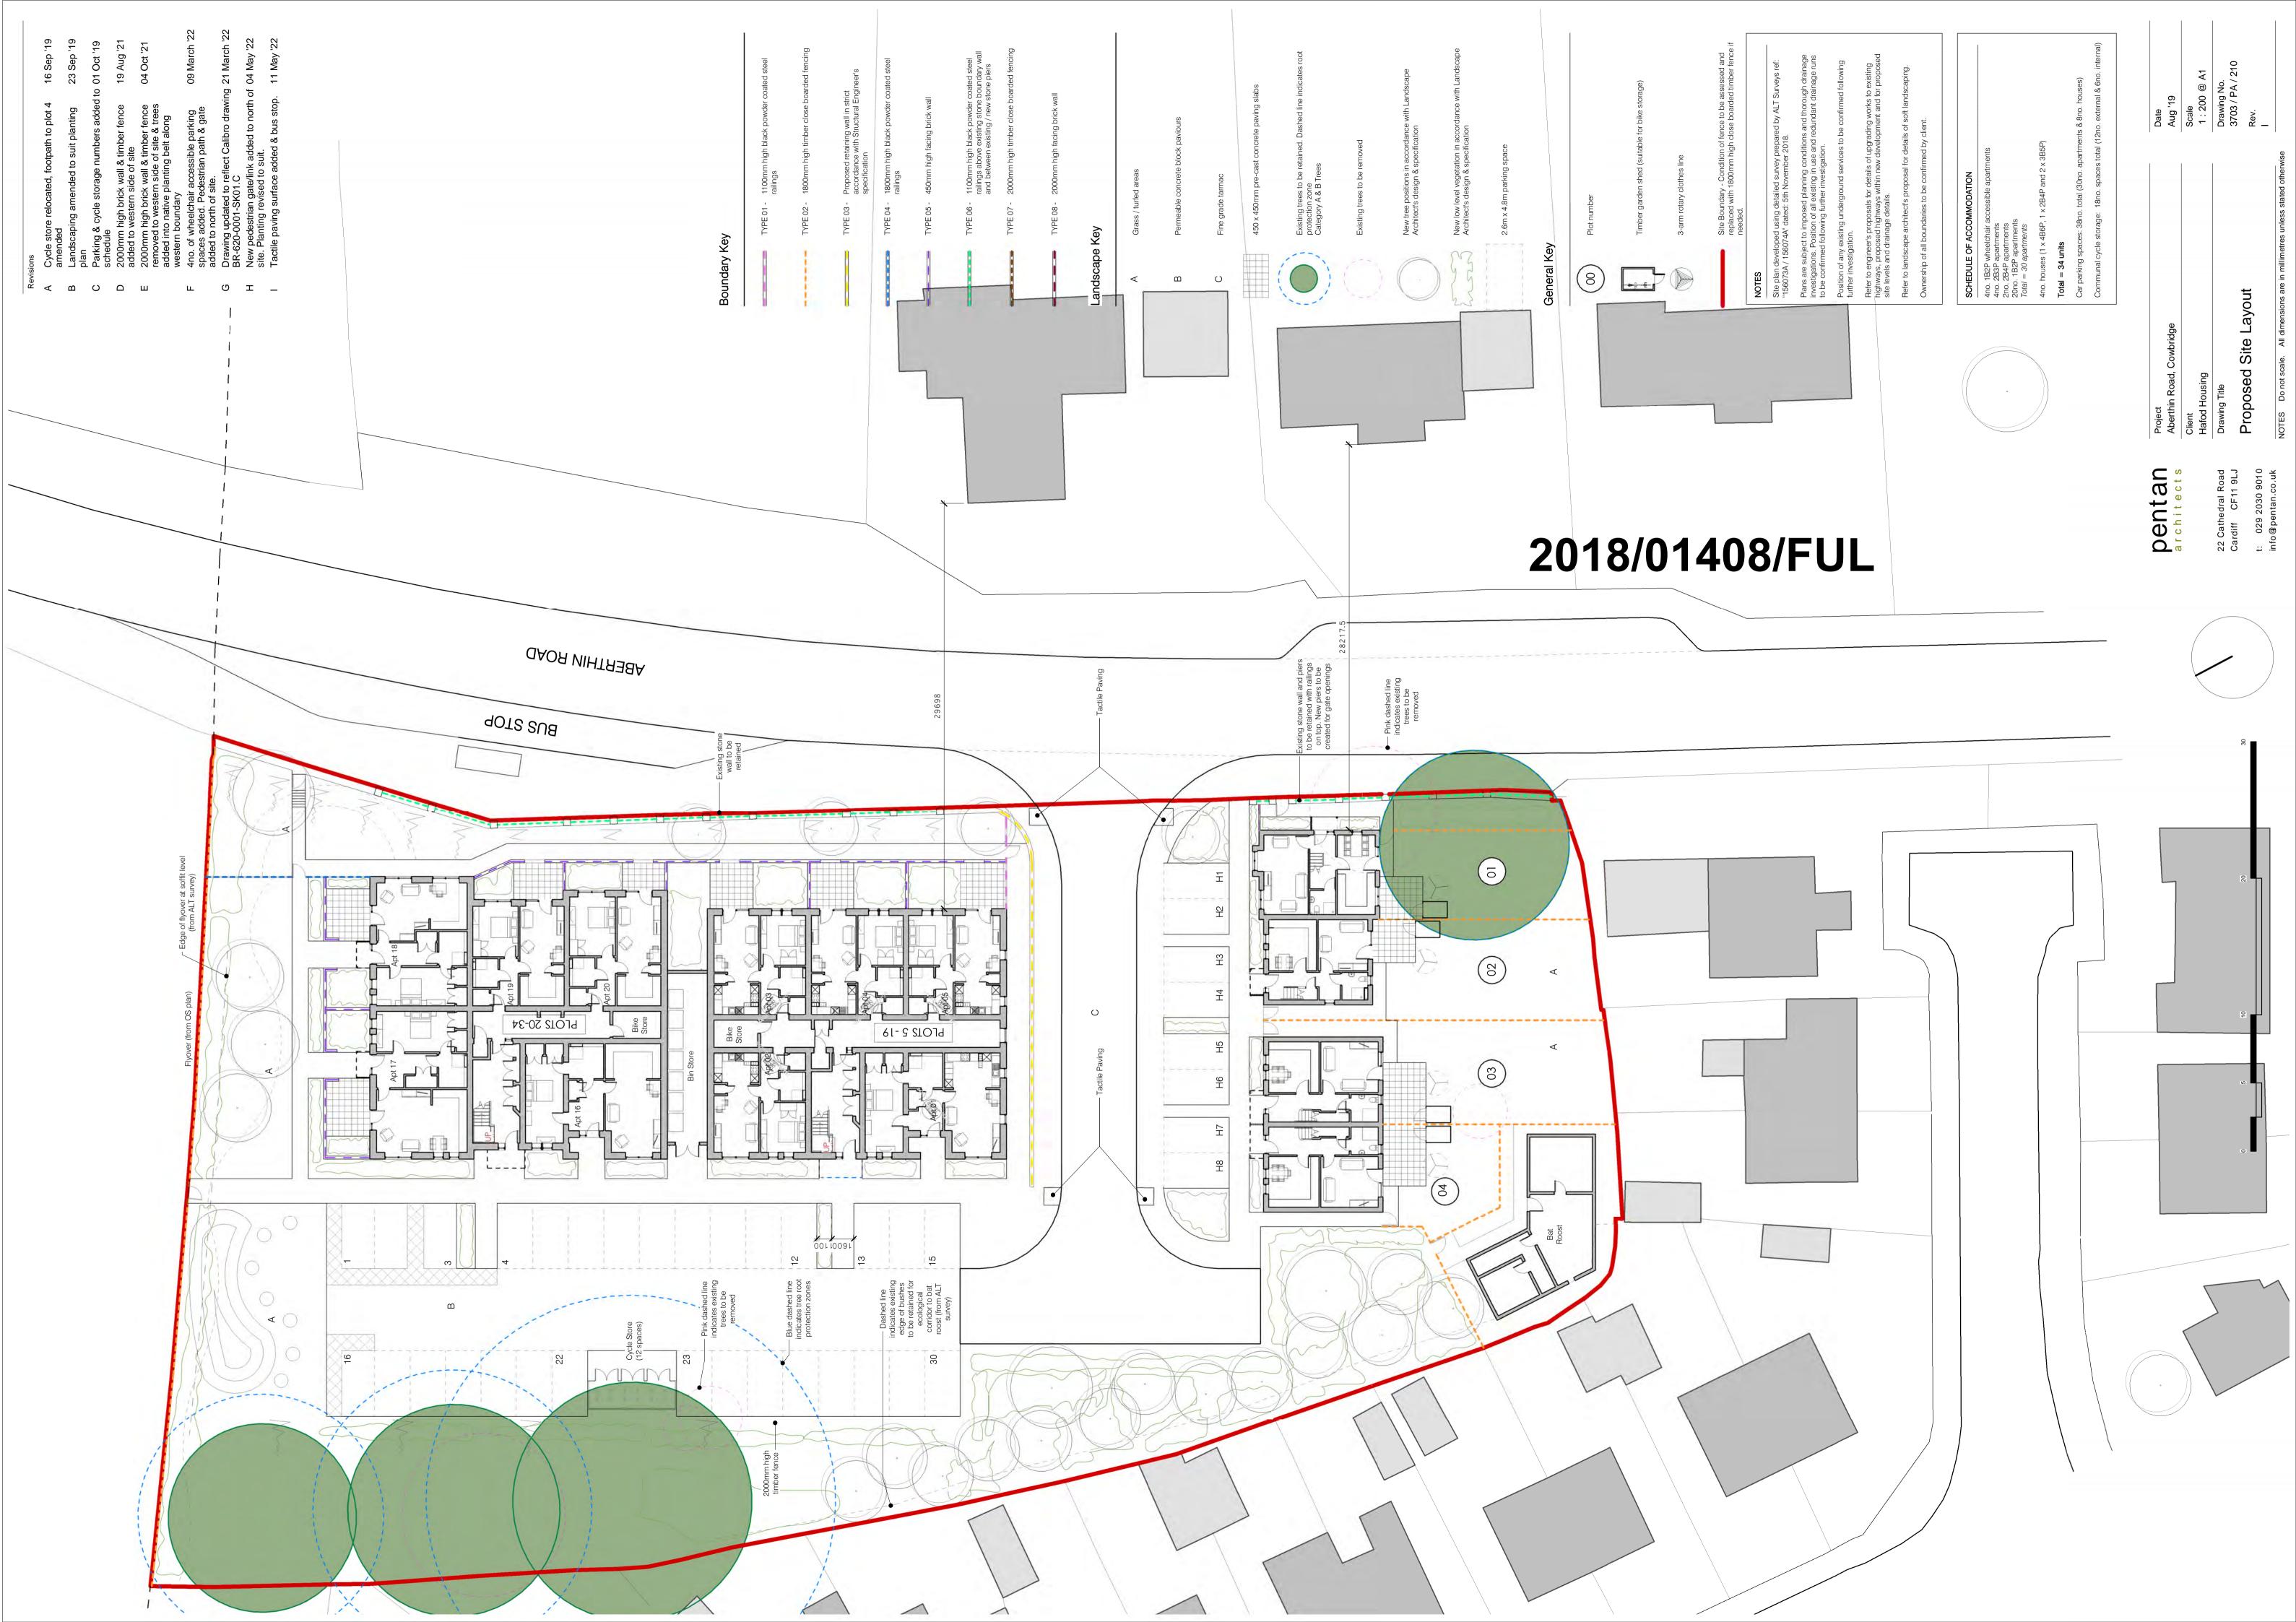

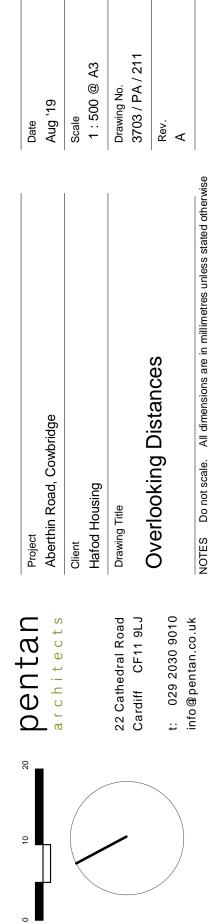





Front Elevation



Rear Elevation

Elevation Material Key

Tile Hanging

Walls Brickwork Type 01- Grey, stock, light textured facing brickwork with neutral mortar Stonework Stone or reconstituted facing stonework

> Fibre cement slate tile hanging. Colour Blue/ Grey. On top continuous stone cill & Aluminium powder coated window formers

> > Stone coping system to all parapet walls

Windows and Doors Window Doors

Cill

Double glazed, PVCu, Pebble Grey- RAL 7032 Composite GRP units, Pebble Grey- RAL 7032 Powder-coated aluminium, RAL 7036

Roof Pitched Roof

Entrance Canopy

& Hoppers

Fibre cement slate tiles. Colour- Blue/Grey Flat Roof Over Central Single-ply membrane. Colour Lead Grey Mansard Section

Composite GRP, RAL 7036, timber posts

Fascias & Soffits Power coated aluminium, RAL 7036

Gutters & Downpipes Powder coated aluminum circular downpipes & deep flow, half round gutters.


Notes:

schedules.

clearly identified.


stated.

Revisions A Notes key added

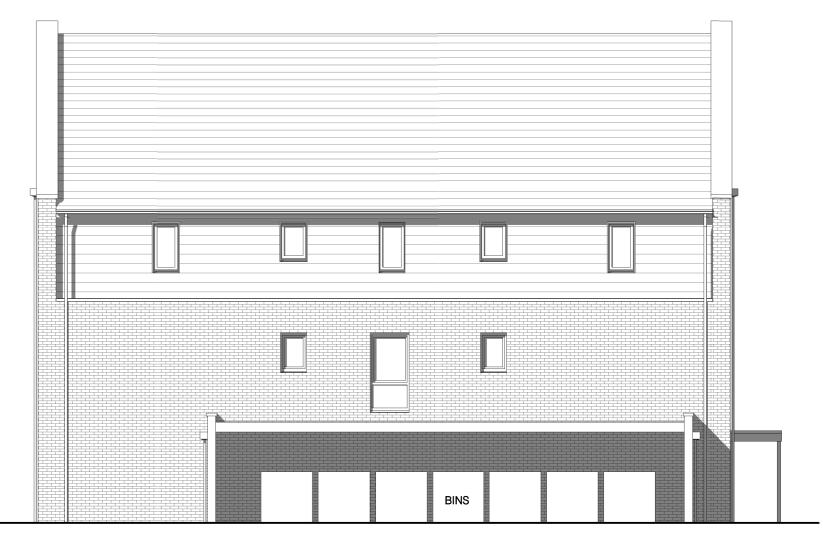

Side Elevation- North

2018/01408/FUL

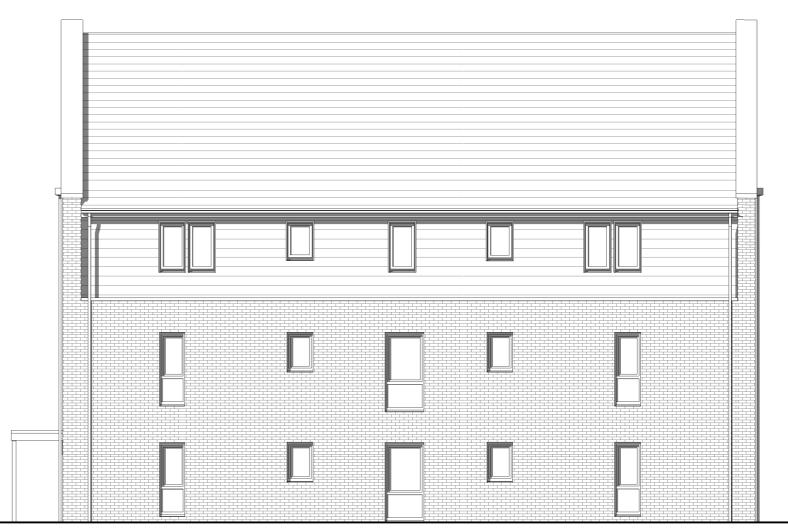

Side Elevation - South

Read in conjunction with all other relevant project drawings and

Drawings must not be scaled and any discrepancies must be reported immediately.

Drawings must be printed in colour to ensure all elements are

Ensure this document is only used for its intended purpose, the suitability is defined by the status code below. Pentan accepts no liability if used for any purpose other then that specifically

Service penetrations: Service extract terminals and flues are to be rectangular, flush and colour matched to surrounding brick/slate. All locations are to be confirmed by M&E consultant, architect and approved by LPA.

pentan architects

22 Cathedral Road Cardiff CF11 9LJ

t: 029 2030 9010 info@pentan.co.uk

Project	Date
Aberthin Road, Cowbridge	Aug 19'
Client	Scale
Hafod Housing	1 : 100 @ A2

Drawing Title

Apartment Block A -

Proposed Elevations NOTES Do not scale. All dimensions are in millimetres unless stated otherwise

2 410
Aug 19'
Scale 1 : 100 @ A2
Drawing No. 3703 / PA / 216
Rev. A

15





Rear Elevation

Elevation Material Key

Walls Brickwork	Type 02-	Cream buff, stock, light textured facing brickwork with neutral mortar
Stonework	· ,- ,	Stone or reconstituted facing stonework
		Stone coping system to all parapet walls

Windows and Doors Window		
Doors		
Cill		

Double glazed, PVCu, Pebble Grey- RAL 7032 Composite GRP units, Pebble Grey- RAL 7032 Powder-coated aluminium, RAL 7036

Roof Pitched Roof	Fibre cement slate tiles. Colour- Blue/Grey
Flat Roof Over Central Mansard Section	Single-ply membrane. Colour Lead Grey
Entrance Canopy	Composite GRP, RAL 7036, timber posts
Fascias & Soffits	Power coated aluminium, RAL 7036
Gutters & Downpipes & Hoppers	Powder coated aluminum circular downpipes & deep flow, half round gutters

Notes:

Read in conjunction with all other relevant project drawings and schedules.

Ensure this document is only used for its intended purpose, the suitability is defined by the status code below. Pentan accepts no liability if used for any purpose other then that specifically stated.


Service penetrations: Service extract terminals and flues are to be rectangular, flush and colour matched to surrounding brick/slate. All locations are to be confirmed by M&E consultant, t: 029 2030 9010 architect and approved by LPA.

Revisions A Notes key added



Side Elevation - North

2018/01408/FUL

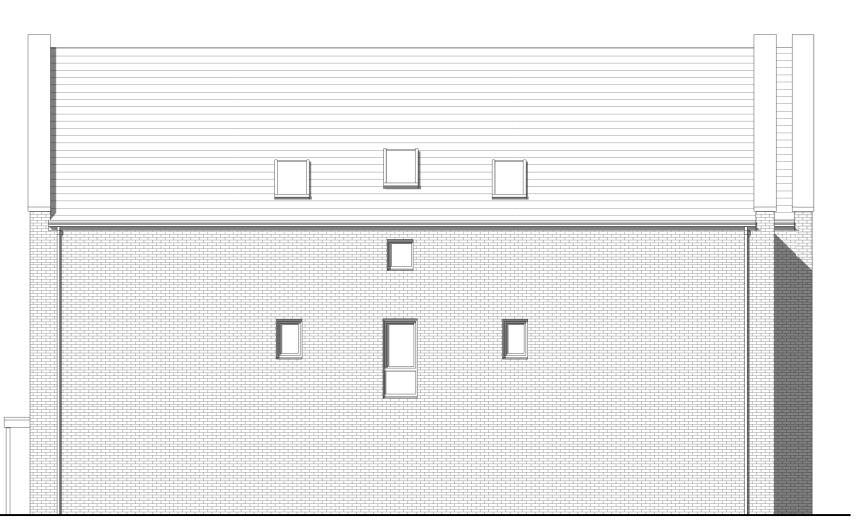

Side Elevation - South

Drawings must not be scaled and any discrepancies must be reported immediately.

Drawings must be printed in colour to ensure all elements are clearly identified.



22 Cathedral Road Cardiff CF11 9LJ

info@pentan.co.uk

15 Project

Aberthin Road, Cowbridge


Client Hafod Housing

Drawing Title


Apartment Block B - Elevations

NOTES Do not scale. All dimensions are in millimetres unless stated otherwise

Date
Aug 19'
Scale
1 : 100 @ A2
Drawing No.
3703 / PA / 221
Rev.
A

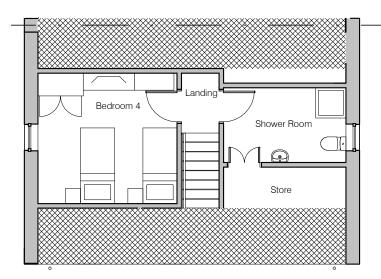

Second Floor Plan

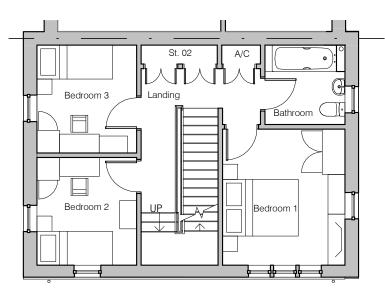

Front Elevation



Side Elevation 2

First Floor Plan



Elevation Material Key

Wall Brickwork Type 01-	Grey, stock, light textured facing brickwork with neutral mortar
Stonework <u>)</u>	Stone or reconstituted facing stonework
	Stone coping to all parapet walls
Tile Hanging	Fibre cement slate tile hanging. Colour Blue/ Grey. On top continuous stone cill & Aluminium powder coated window formers
Windows and Doors Window & Rear doors	Double glazed, PVCu, Pebble Grey- RAL 7032
Front Doors	Composite GRP units, Pebble Grey- RAL 7032
Cills	Powder-coated aluminium, RAL 7036
Roof Pitched Roof	Fibre cement slate tiles. Colour- Blue/Grey
Entrance Canopy	Composite GRP, RAL 7036, timber posts
Fascias & Soffits	Power coated aluminium, RAL 7036
Gutters & Downpipes & Hoppers	Powder coated aluminum circular downpipes

& deep flow, half round gutters.

Notes:

Read in conjunction with all other relevant project drawings and schedules.

Drawings must not be scaled and any discrepancies must be reported immediately.

Drawings must be printed in colour to ensure all elements are clearly identified.

Ensure this document is only used for its intended purpose, the suitability is defined by the status code below. Pentan accepts no liability if used for any purpose other then that specifically stated.

Service penetrations: Service extract terminals and flues are to be rectangular, flush and colour matched to surrounding brick/slate. All locations are to be confirmed by M&E consultant, architect and approved by LPA.



Project
Aberthin Road
Client

Hafod Resources

Drawing Title

pentan

architects

22 Cathedral Road Cardiff CF11 9LJ

t: 029 2030 9010 info@pentan.co.uk

4B6P House Plans & E

NOTES Do not scale. All dimensions are

Revisions

A Elevation material key revised & notes added 24 Sep '19





Side Elevation 1

2018/01408/FUL

	10 1!	5
	Date	
	AUG '19	
	Scale	
	1 : 100 @ A3	
levations	Drawing No.	
	3703 / PA / 225	
	Rev.	
	Α	
in millimetres unless stated othe	erwise	



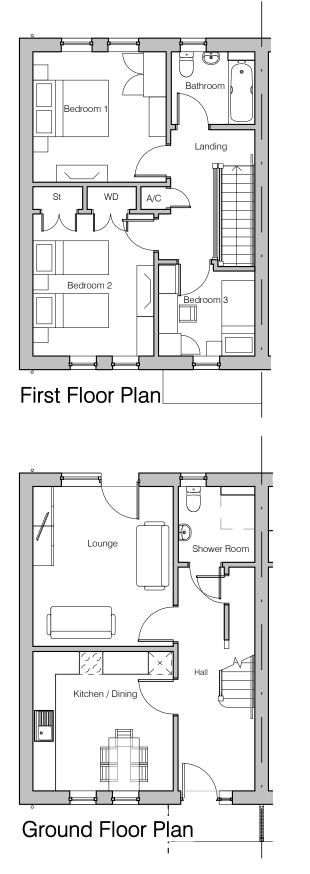

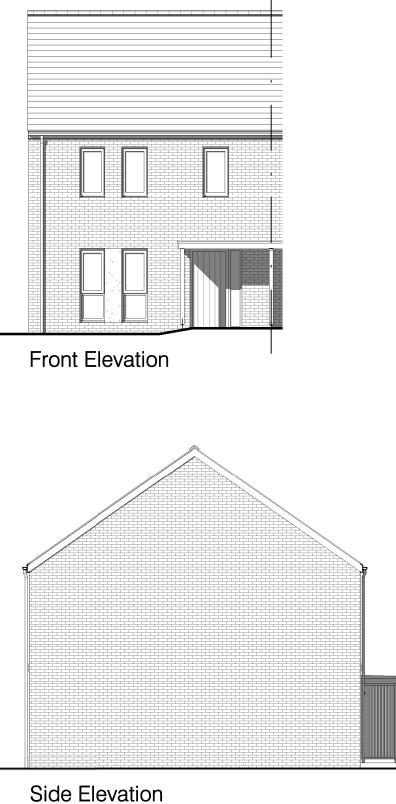

Notes:

Read in conjunction with all other relevant project drawings and schedules.

Drawings must not be scaled and any discrepancies must be reported immediately.

Drawings must be printed in colour to ensure all elements are clearly identified.

Ensure this document is only used for its intended purpose, the suitability is defined by the status code below. Pentan accepts no liability if used for any purpose other then that specifically stated.

Service penetrations: Service extract terminals and flues are to be rectangular, flush and colour matched to surrounding brick/slate. All locations are to be confirmed by M&E consultant, architect and approved by LPA.

pentan architects

22 Cathedral Road

Cardiff CF11 9LJ

t: 029 2030 9010

info@pentan.co.uk

Client Hafod Resources

3B5P House Plans & Elevations

NOTES Do not scale. All dimensions are in millimetres unless stated otherwise

Rear Elevation

Elevation Material Key

Wall Stonework

Aluminium coping system to all parapet walls, RAL 7036

Windows and Doors

Front Doors Composite GRP units, Pebble Grey- RAL 7032 Cills Powder-coated aluminium, RAL 7036 Roof Pitched Roof Fibre cement slate tiles. Colour- Blue/Grey Entrance Canopy Composite GRP, RAL 7036, timber posts Fascias & Soffits Power coated aluminium, RAL 7036 Gutters & Downpipes & Hoppers Powder coated aluminum circular downpipes & deep flow, half round gutters.

Project

Aberthin Road, Cowbridge

Drawing Title


Revisions

A Elevation material key revised & notes added 24 Sep '19




2018/01408/FUL

- Brickwork Type 01- Grey, stock, light textured facing brickwork with neutral mortar
 - Stone or reconstituted facing stonework
- Window & Rear doors Double glazed, PVCu, Pebble Grey- RAL 7032

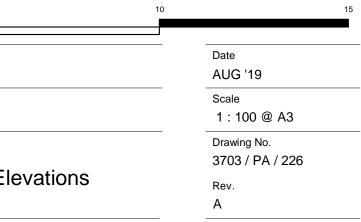



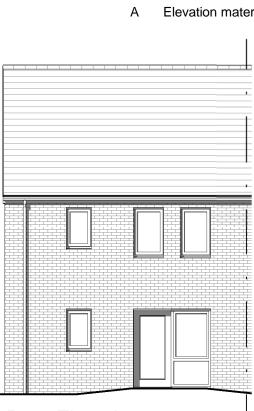

Wall Brickwork Ty	ype 01-	Grey, sto with neut
Stonework	, _ ` ,	Stone or
Aluminium co	ping syste	em to all p
Windows and Window & Re		Double g
Front Doors		Compos 7032
Cills		Powder-
Roof Pitched Roof		Fibre cer
Entrance Can	ору	Compos
Fascias & Sof	fits	Power co
Gutters & Dov & Hoppers	vnpipes	Powder o & deep f



Client Hafod Resources

Drawing Title


2B4P House Floor Plan


Rear Elevation Elevation Material Key



Project	
Aberthin Road, Cowbridge	
	_

NOTES Do not scale. All dimensions are in millimetres unless stated otherwise

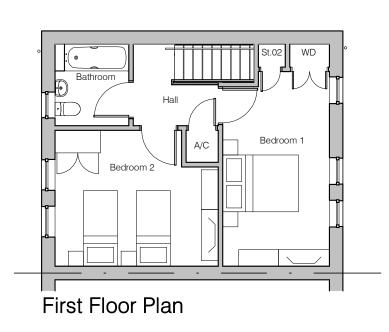

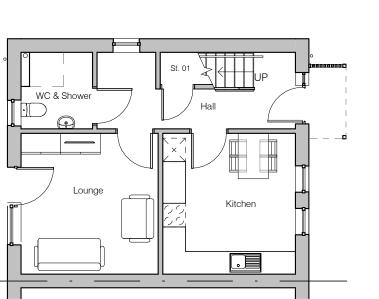

Ground Floor Plan

Notes:


Read in conjunction with all other relevant project drawings and schedules.

Drawings must not be scaled and any discrepancies must be reported immediately.

Drawings must be printed in colour to ensure all elements are clearly identified.

Ensure this document is only used for its intended purpose, the suitability is defined by the status code below. Pentan accepts no liability if used for any purpose other then that specifically stated.

Service penetrations: Service extract terminals and flues are to be rectangular, flush and colour matched to surrounding brick/slate. All locations are to be confirmed by M&E consultant, architect and approved by LPA.

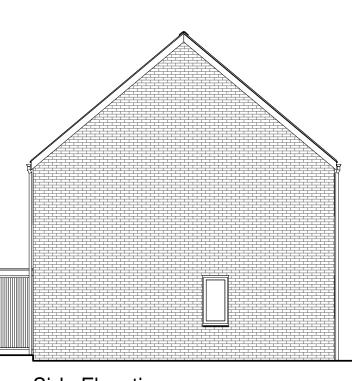

Side Elevation

Front Elevation

pentan architects

22 Cathedral Road Cardiff CF11 9LJ

t: 029 2030 9010 info@pentan.co.uk

Revisions

A Elevation material key revised & notes added 24 Sep '19

- ock, light textured facing brickwork tral mortar
- reconstituted facing stonework
- parapet walls, RAL 7036
- glazed, PVCu, Pebble Grey- RAL 7032
- site GRP units, Pebble Grey- RAL
- coated aluminium, RAL 7036
- ment slate tiles. Colour- Blue/Grey
- site GRP, RAL 7036, timber posts
- oated aluminium, RAL 7036

coated aluminum circular downpipes low, half round gutters.

	10 13
	Date
	AUG '19
	Scale
	1 : 100 @ A3
	Drawing No.
	3703 / PA / 227
ns & Elevations	Rev.
	А

15



Street Elevation From Ground Floor Level



Street Elevation From Ground Floor Level

2018/01408/FUL

pentan architects

22 Cathedral Road Cardiff CF11 9LJ

t: 029 2030 9010 info@pentan.co.uk N.B Images are artist impressions. For illustrative purposes only

Project Aberthin Road, Cowbridge

Client Hafod Housing

Drawing Title Proposed Street Elevations: Coloured

Date SEP '19 Scale NTS Drawing No. 3703-PA-240 Rev. -

NOTES. Do not scale. All dimensions are in millimetres unless stated otherwise



Rear Elevation From Ground Floor Level



Front Elevation of Houses

2018/01408/FUL



Cardiff CF11 9LJ

t: 029 2030 9010 info@pentan.co.uk

N.B Images are artist impressions. For illustrative purposes only

Revisions

Project

22 Cathedral Road

Aberthin Road, Cowbridge

Client

Hafod Housing

Drawing Title Proposed Rear Apartments & Houses Steetscene: Coloured

SEP '19 Scale NTS Drawing No. 3703-PA-241 Rev. -

Date

NOTES. Do not scale. All dimensions are in millimetres unless stated otherwise

2018/01408/FUL



View from Aberthin Road looking North towards flyover




View from Aberthin Road looking South- West



South-east facing elevations of the south-west end of the school building



South-east facing elevations of the north-east end of the school building

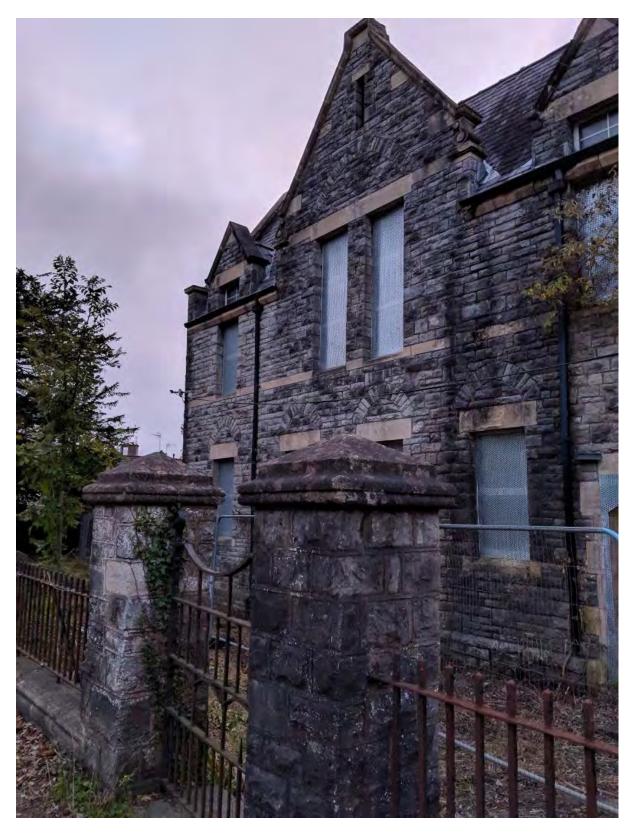

Facing gable on the south-east elevation.



North-west facing elevation of the 1896 part of the building.



South-west facing elevation of the school building



Rear of site - two remaining 1950s buildings and the stone wall remnant of the older outbuilding



Aeria Photo of site





Revisions

A Minor amendments B Redline amended PC 27.04.21 PC 25.11.21

2021/00622/FUL

Notes

Do not scale from this drawing. Use figured dimensions only, which are displayed in millimeters unless stated otherwise. The contractor is requested to check all dimensions before work is put in hard. Any discrepancies within the drawing should be reported prior to commencement of works.

Copyright of this drawing belongs solely to CMKA Ltd. This drawing must only be used for the purpose for which it is supplied and its contents must not be reproduced for any purpose without written permission.


CHAMBERLAIN MOSS KING

> 97a Glebe Street | Penarth Vale of Glamorgan | CF64 1EE


T. 02920 306400 chamberlainkingmoss.co.uk

Project	HOLTON ROAD, BARRY
Project numb	er N309
Client	KESTRAL CONSTRUCTION LTD
Title	SITE LOCATION PLAN
Drawing num	ber A100
Scale	1 : 1250 at A3
Revision	В
Status	PLANNING
Drawn	PC
Date	27.04.21

Proposed first floor plan

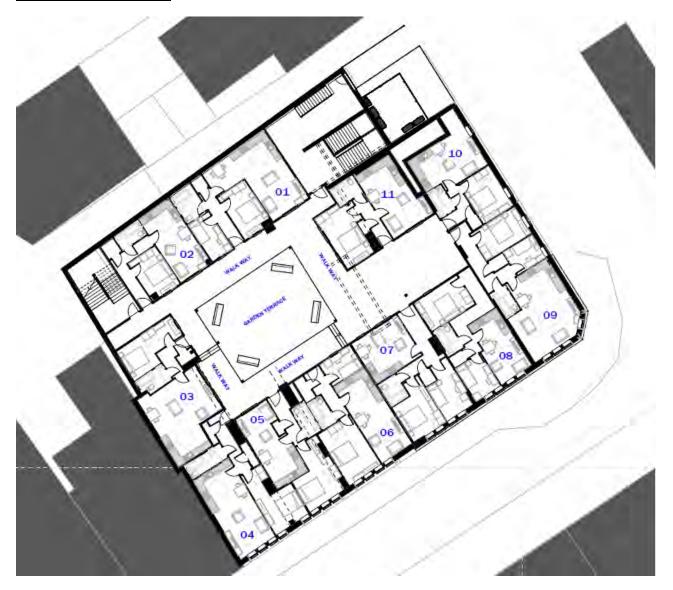

Proposed third floor plan

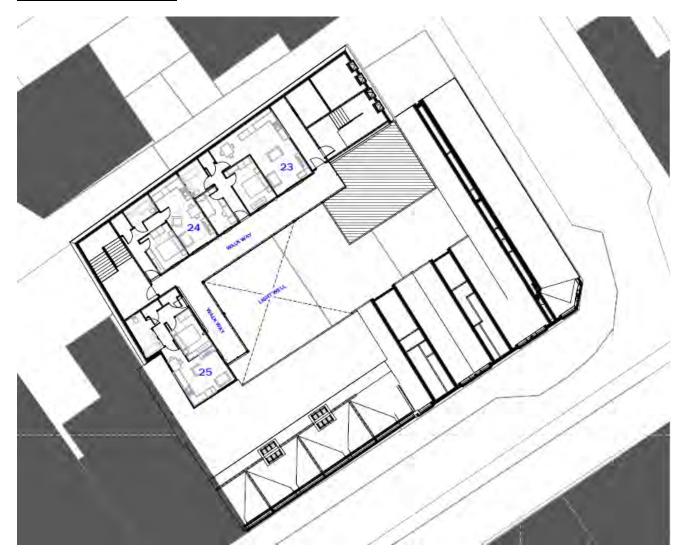


Existing and proposed elevations






Site photograph 1 – view from alley way (side and rear elevations)

Site photograph 2 – view of side elevation from Newlands Street

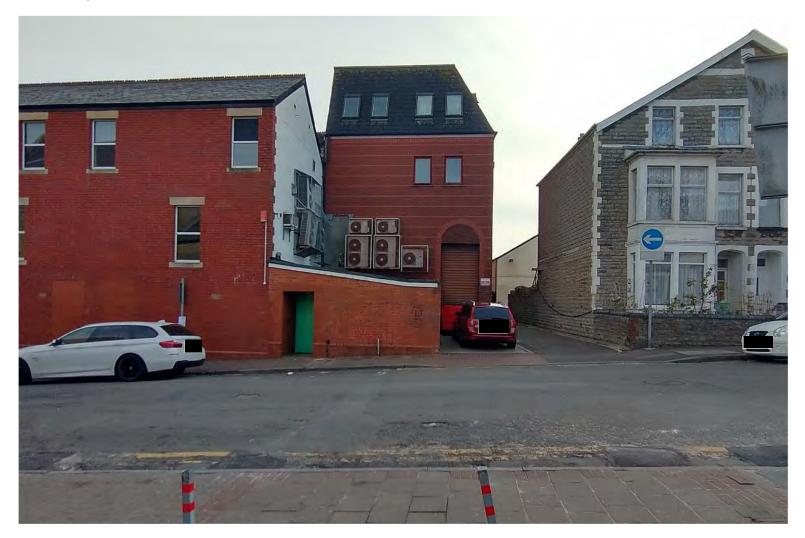

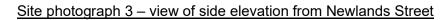




Site photograph 4 – view of Newlands Street



Site photograph 5 – front of building (Holton Road)

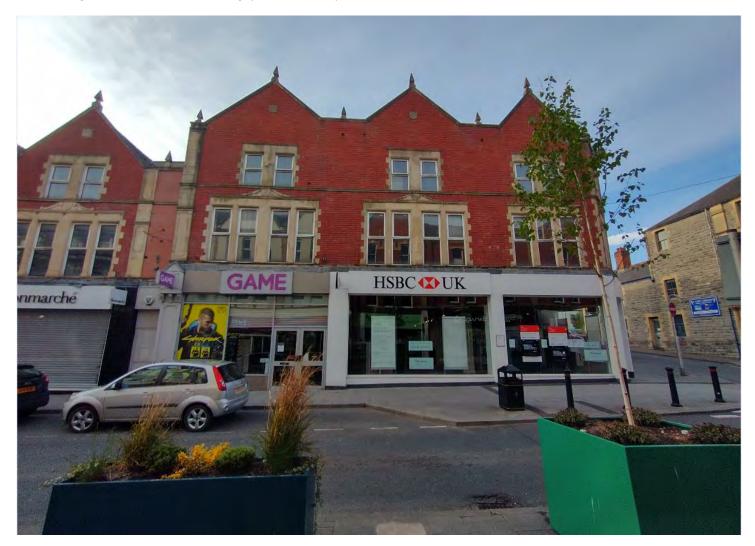


2021/00622/FUL - 81 - 85 Holton Road, Barry


Site photograph 6 – front of building (Holton Road)



Site Location

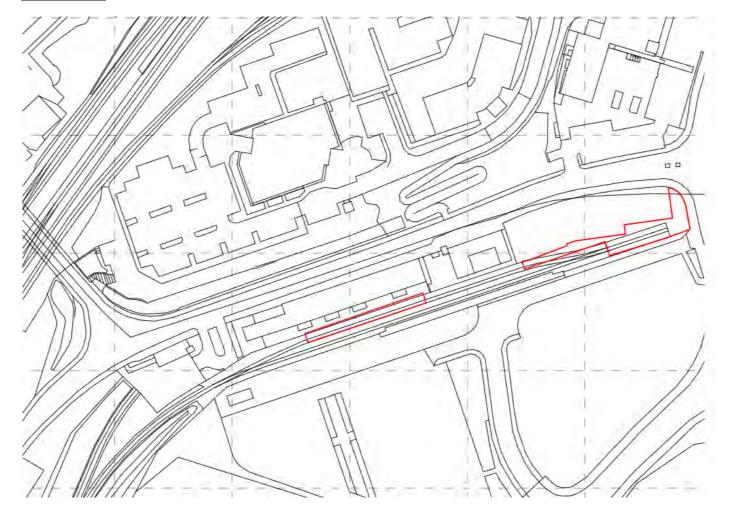


Proposed Ground Floor/ Site Layout

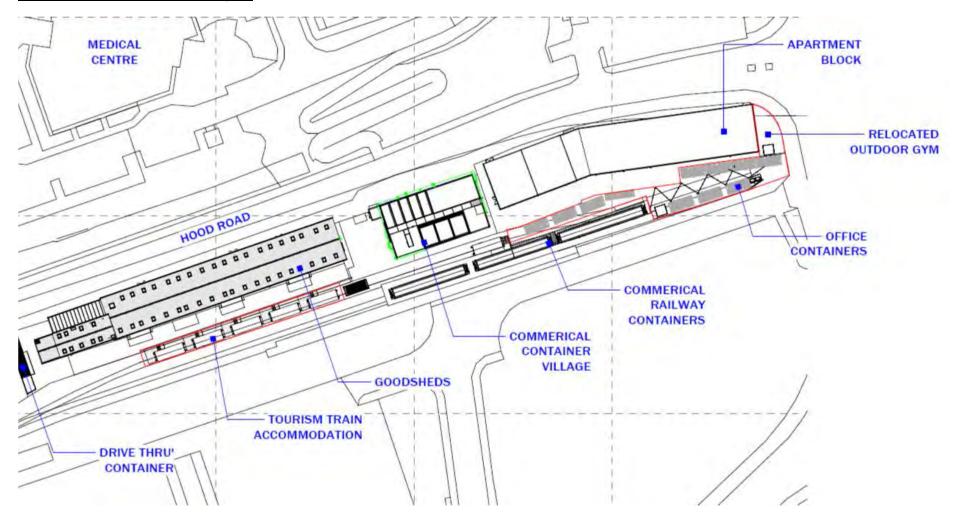

Proposed rail carriage elevations




02 TOALD CARRINGES - ELEVATION 9

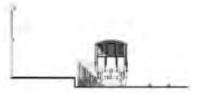

03 TOALD CARRIAGES ; ELEVATION C



04 TOALD CARRIAGES - ELEVATION D

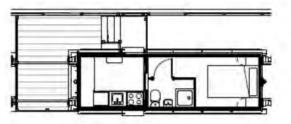

05 DARD GARREAGES . TYPICAL LAYOUT

Proposed elevations



Site photograph 1 – view of Junction House from Hood Road



Site photograph 2 – view toward rear of Goodsheds site from Hood Road



Site photograph 3 – view toward rear of Goodsheds site from Ffordd y Mileniwm



Site photograph 4 – view toward rear of Goodshed building from land to the south




Site photograph 5 – view toward rear of Junction House from land at the south



Site photograph 6 – view toward Goodsheds site from Hood Road




Site Location

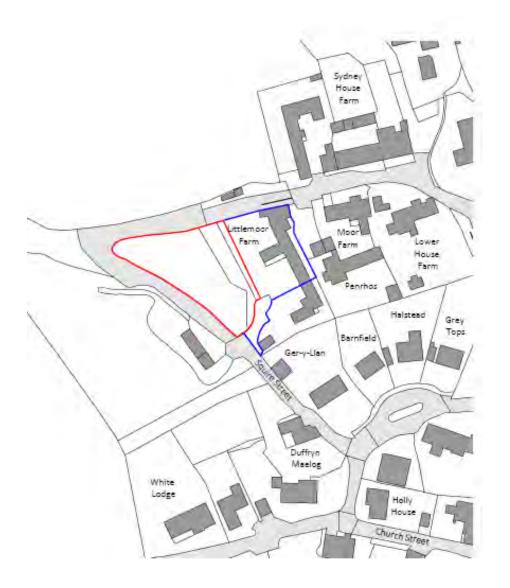

Proposed site layout





Proposed elevations

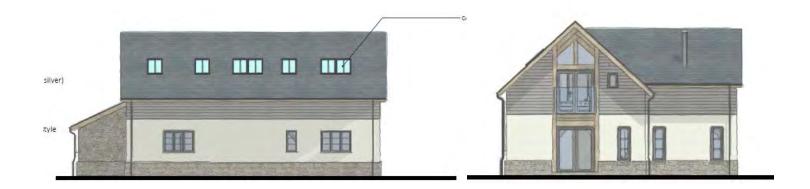



Proposed garage

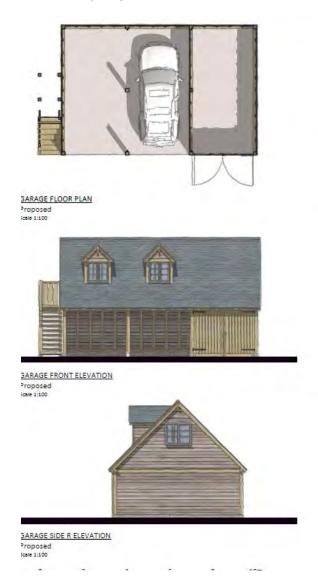

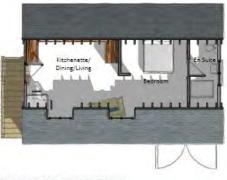

GARAGE ROOM-OVER ANNEXE FLOOR PLAN Proposed Scale 1:00




GARAGE REAR ELEVATION Proposed Scale 1:100



GARAGE SIDE L ELEVATION Proposed Scale 1:100

Proposed context

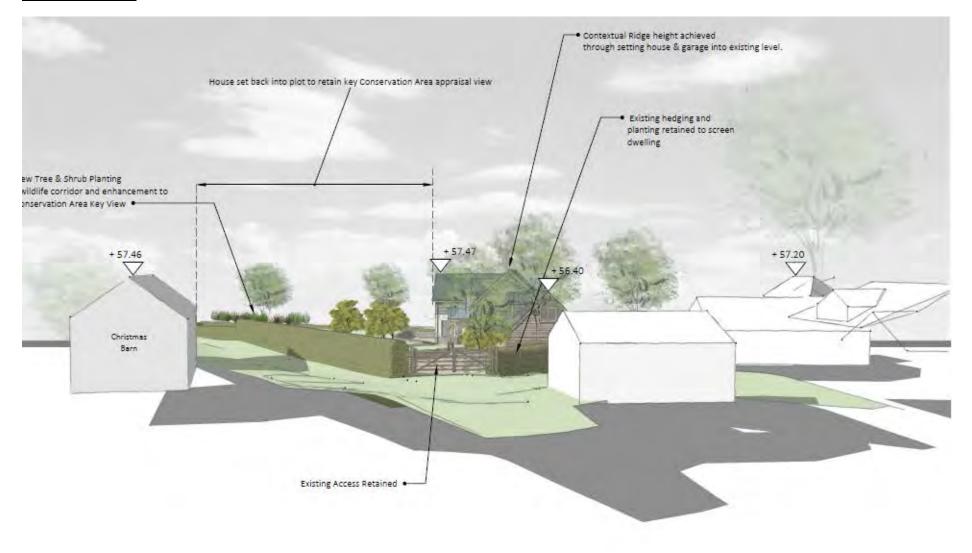

Site photograph 1 – Littlemoor Farm (existing dweling)



Site photograph 2 – view toward Littlemoor Farm from Squire Street (north east)



Site photograph 3 – view toward Littlemoor Farm from Squire Street (north east)



Site photograph 4 – view from Squire Street (north west)



<u>Site photograph 5 – site interior</u>



Site photograph 6 – site interior



Site photograph 7 – site interior



Site photograph 8 – view from Squire Street (south)



Site photograph 9 – view from Squire Street (south)



Site photograph 10 – winter view from Squire Street (south)




Site photograph 11 – winter view from Squire Street (south)




Site photograph 12 – winter site interior



2022/00046/FUL

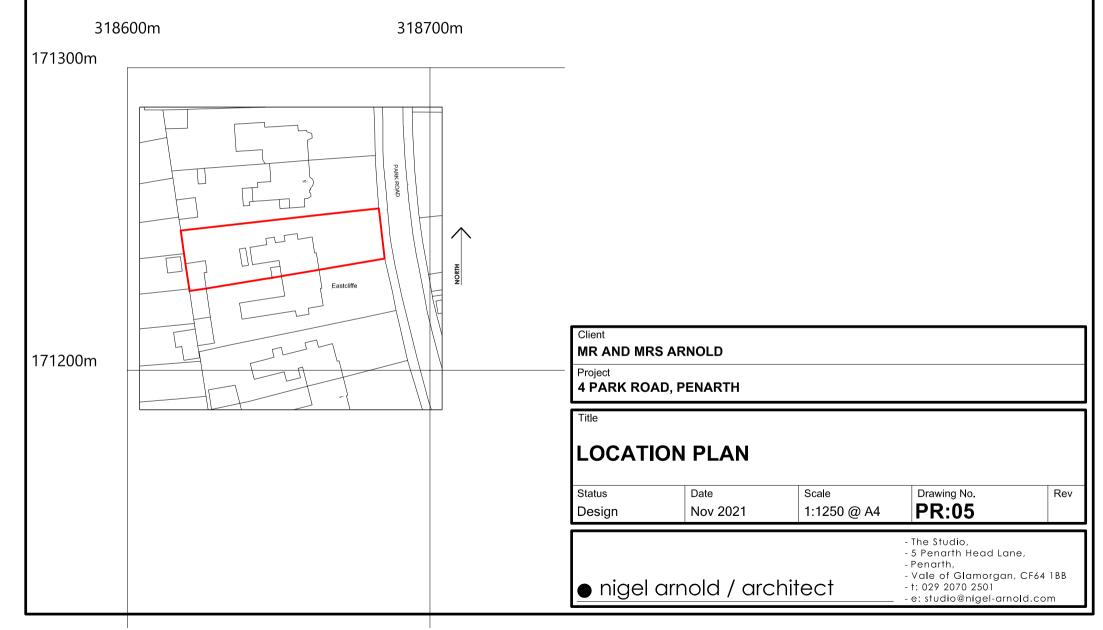



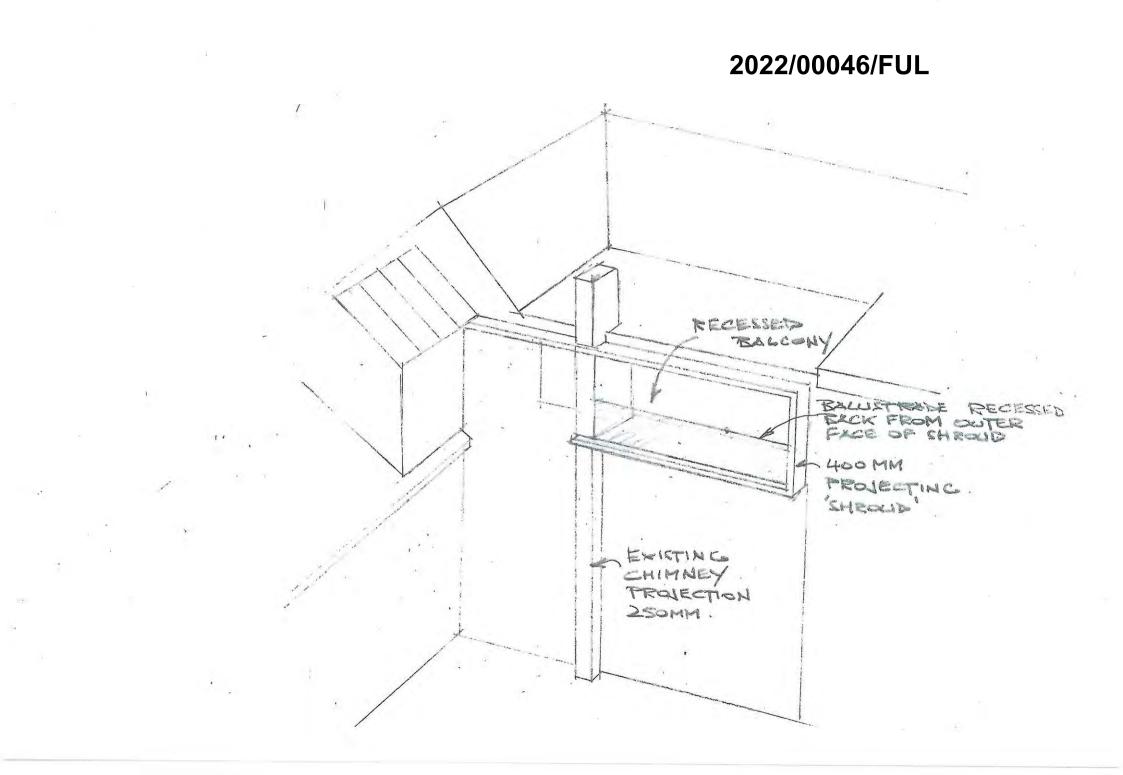

IMG7468 - views from applicants dwelling dormer window towards No3



IMG7519 Applicants side elevation, stood roughly at the entranceway to the applicants dwelling



2022/00046/FUL

IMG7525 – Applicants existing stairway



IMG9160 – No5 side elevation






IMG9177- views from first floor apartemtn towards No5

IMG 7505 - Rear elevation of applicants dwelling and No3







'n	check	date	status	job no	rev
s		09/02/22	PLANNING	AS38	-
		client		drawing numbe	er
		MR DARREN E	VANS	002	

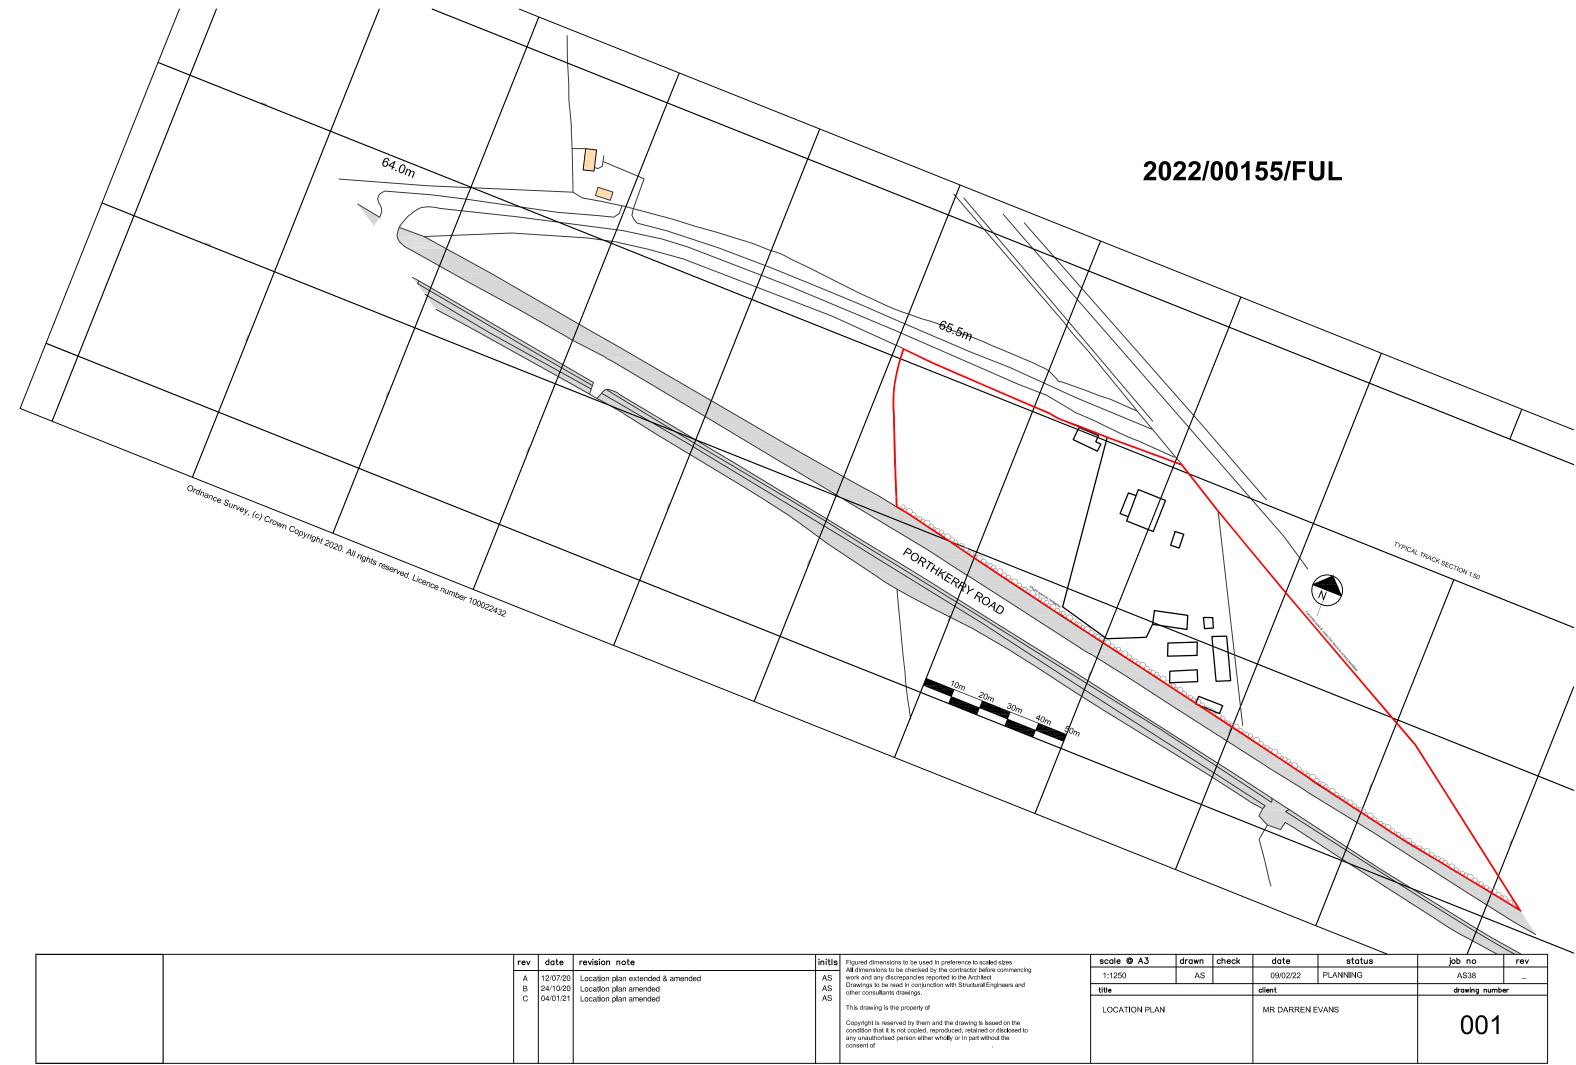

	rev	date	revision note	initls	Figured dimensions to be used in preference to scaled sizes	scale @ A3	draw
	В	24/10/20	Location plan extended & amended Location plan amended Location plan amended	AS AS	All dimensions to be checked by the contractor before commencing work and any discrepancies reported to the Architect Drawings to be read in conjunction with Structural Engineers and other consultants drawings. This drawing is the property of Copyright is reserved by them and the drawing is issued on the condition that it is not copied, reproduced, relained or disclosed to any unauthorised person either wholly or in part without the consent of	1:1250 title LOCATION PLAN	

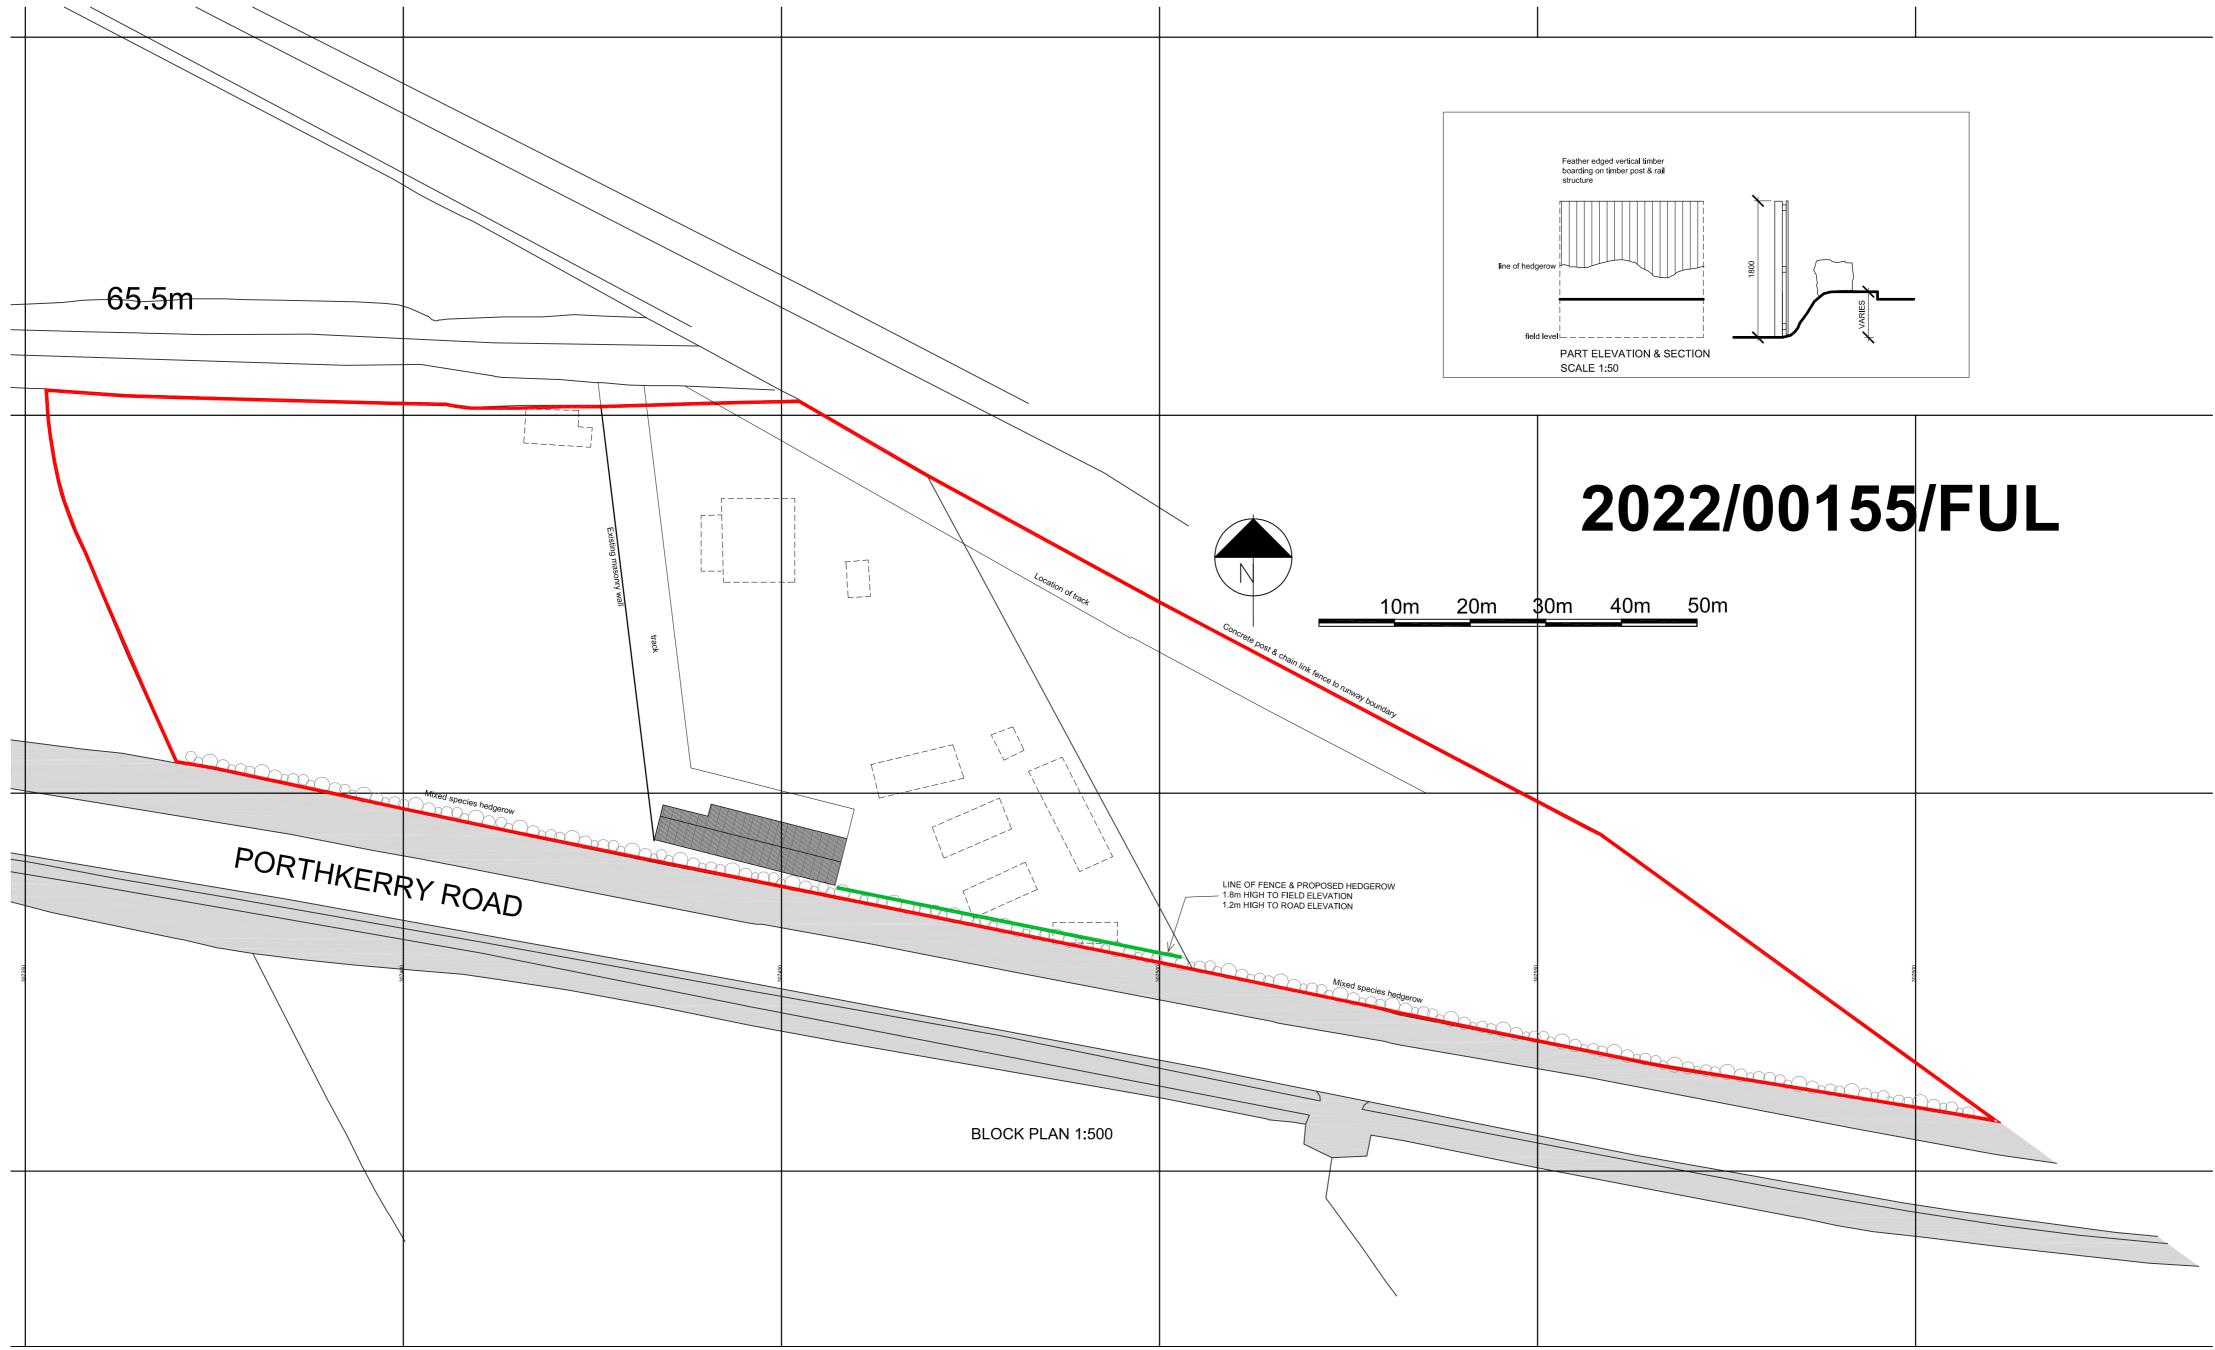

notes	rev date	te revision note	initls	Figured dimensions to be used in preference to scaled sizes	scale @ A2	drawn	check	date	status	job no	rev
5m @ 1:100 2.5m @ 1:50	A 10/03/2	3/22 Fence detail & section added	AS	All dimensions to be checked by the contractor before commencing work and any discrepancies reported to the Architect	1:500	AS		09/02/22	PLANNING	AS38	A
<u> </u>				prawings to be read in conjunction with Structural Engineers and other consultants drawings.	title	•		client		drawing numbe	er
					BLOCK PLAN PROPOSED FENCE			MR DARREN EVANS LAND OFF PORTHKER RHOOSE	RY ROAD	202	

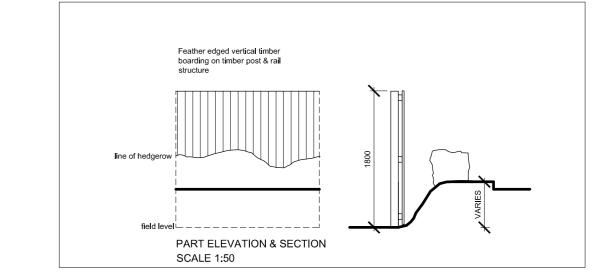

Photos for Committee – Fence at Porthkerry Road – 2022/00155/FUL

1. Fence from Porthkerry Road showing wider views.



2022/00155/FUL



2. Close up images of the fence partially completed



3. Completed section of fence along the road







LOCATION PLAN 1:1250

1010 Architects; info@1010architects.com; tel: 029 20 710100 www.1010architects.com

January 2021

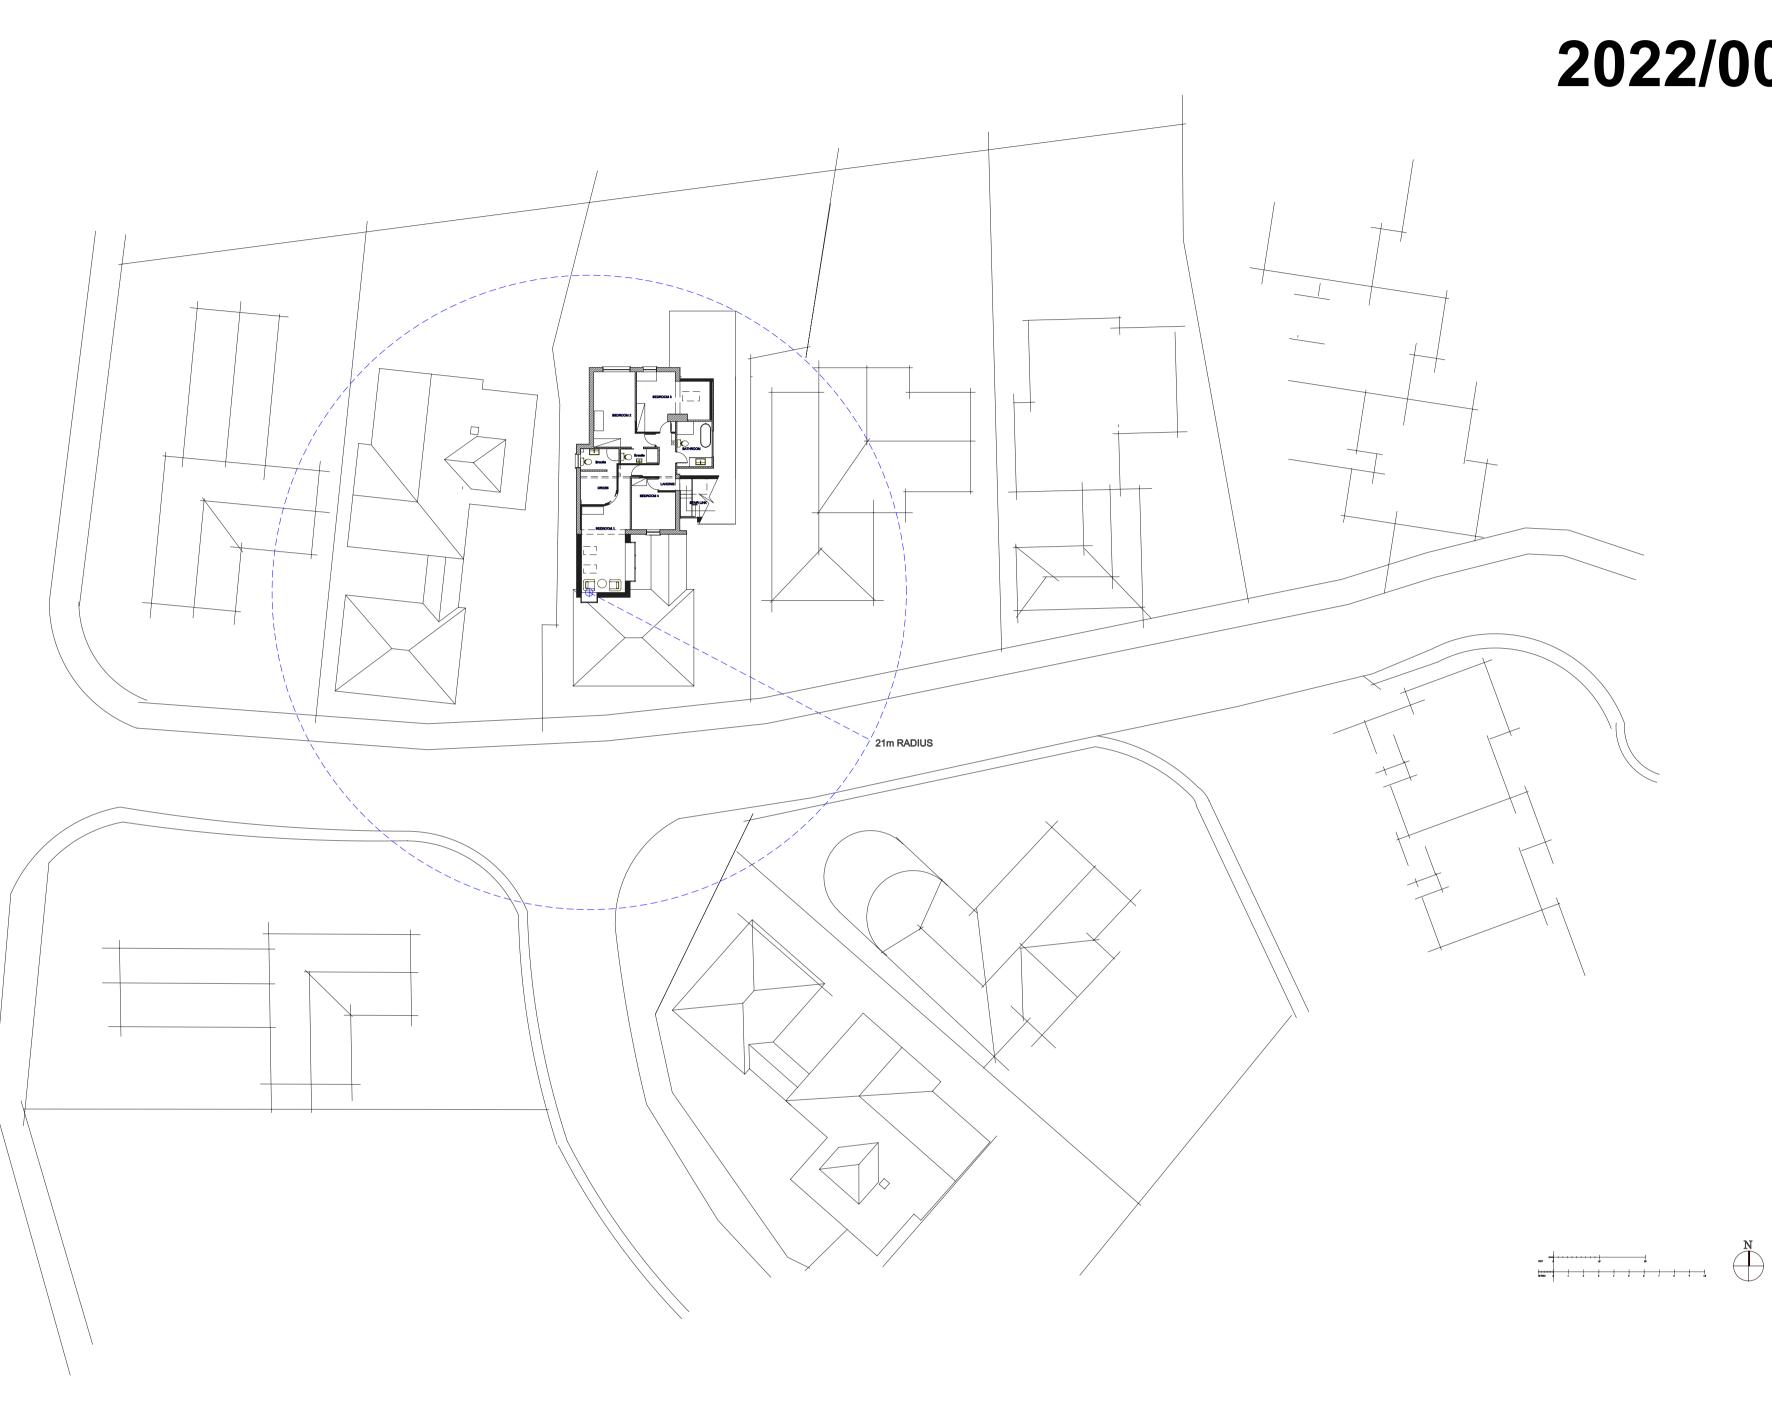

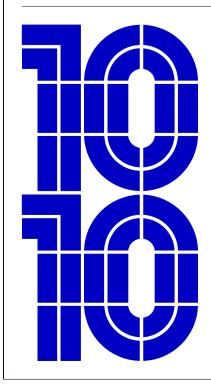

Notes:


Project : Single and two storey extensions, alterations and renovations


Client : Mr and Mrs Markos and Markella Asprou


PLANNING 1010 Architects.

Studio 2 The Coach House, Stanwell Road Penarth, CF64 3EU tel. +44(0) 029 2071 0100 email; info@1010architects.com

2022/00401/FUL

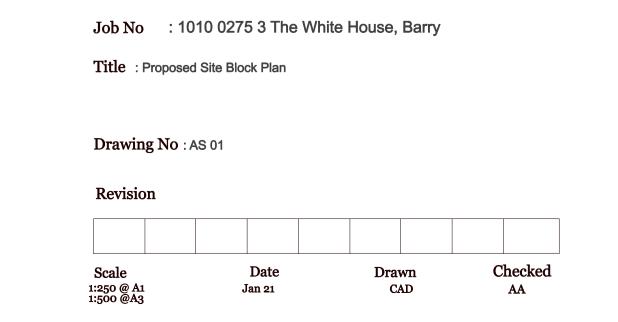

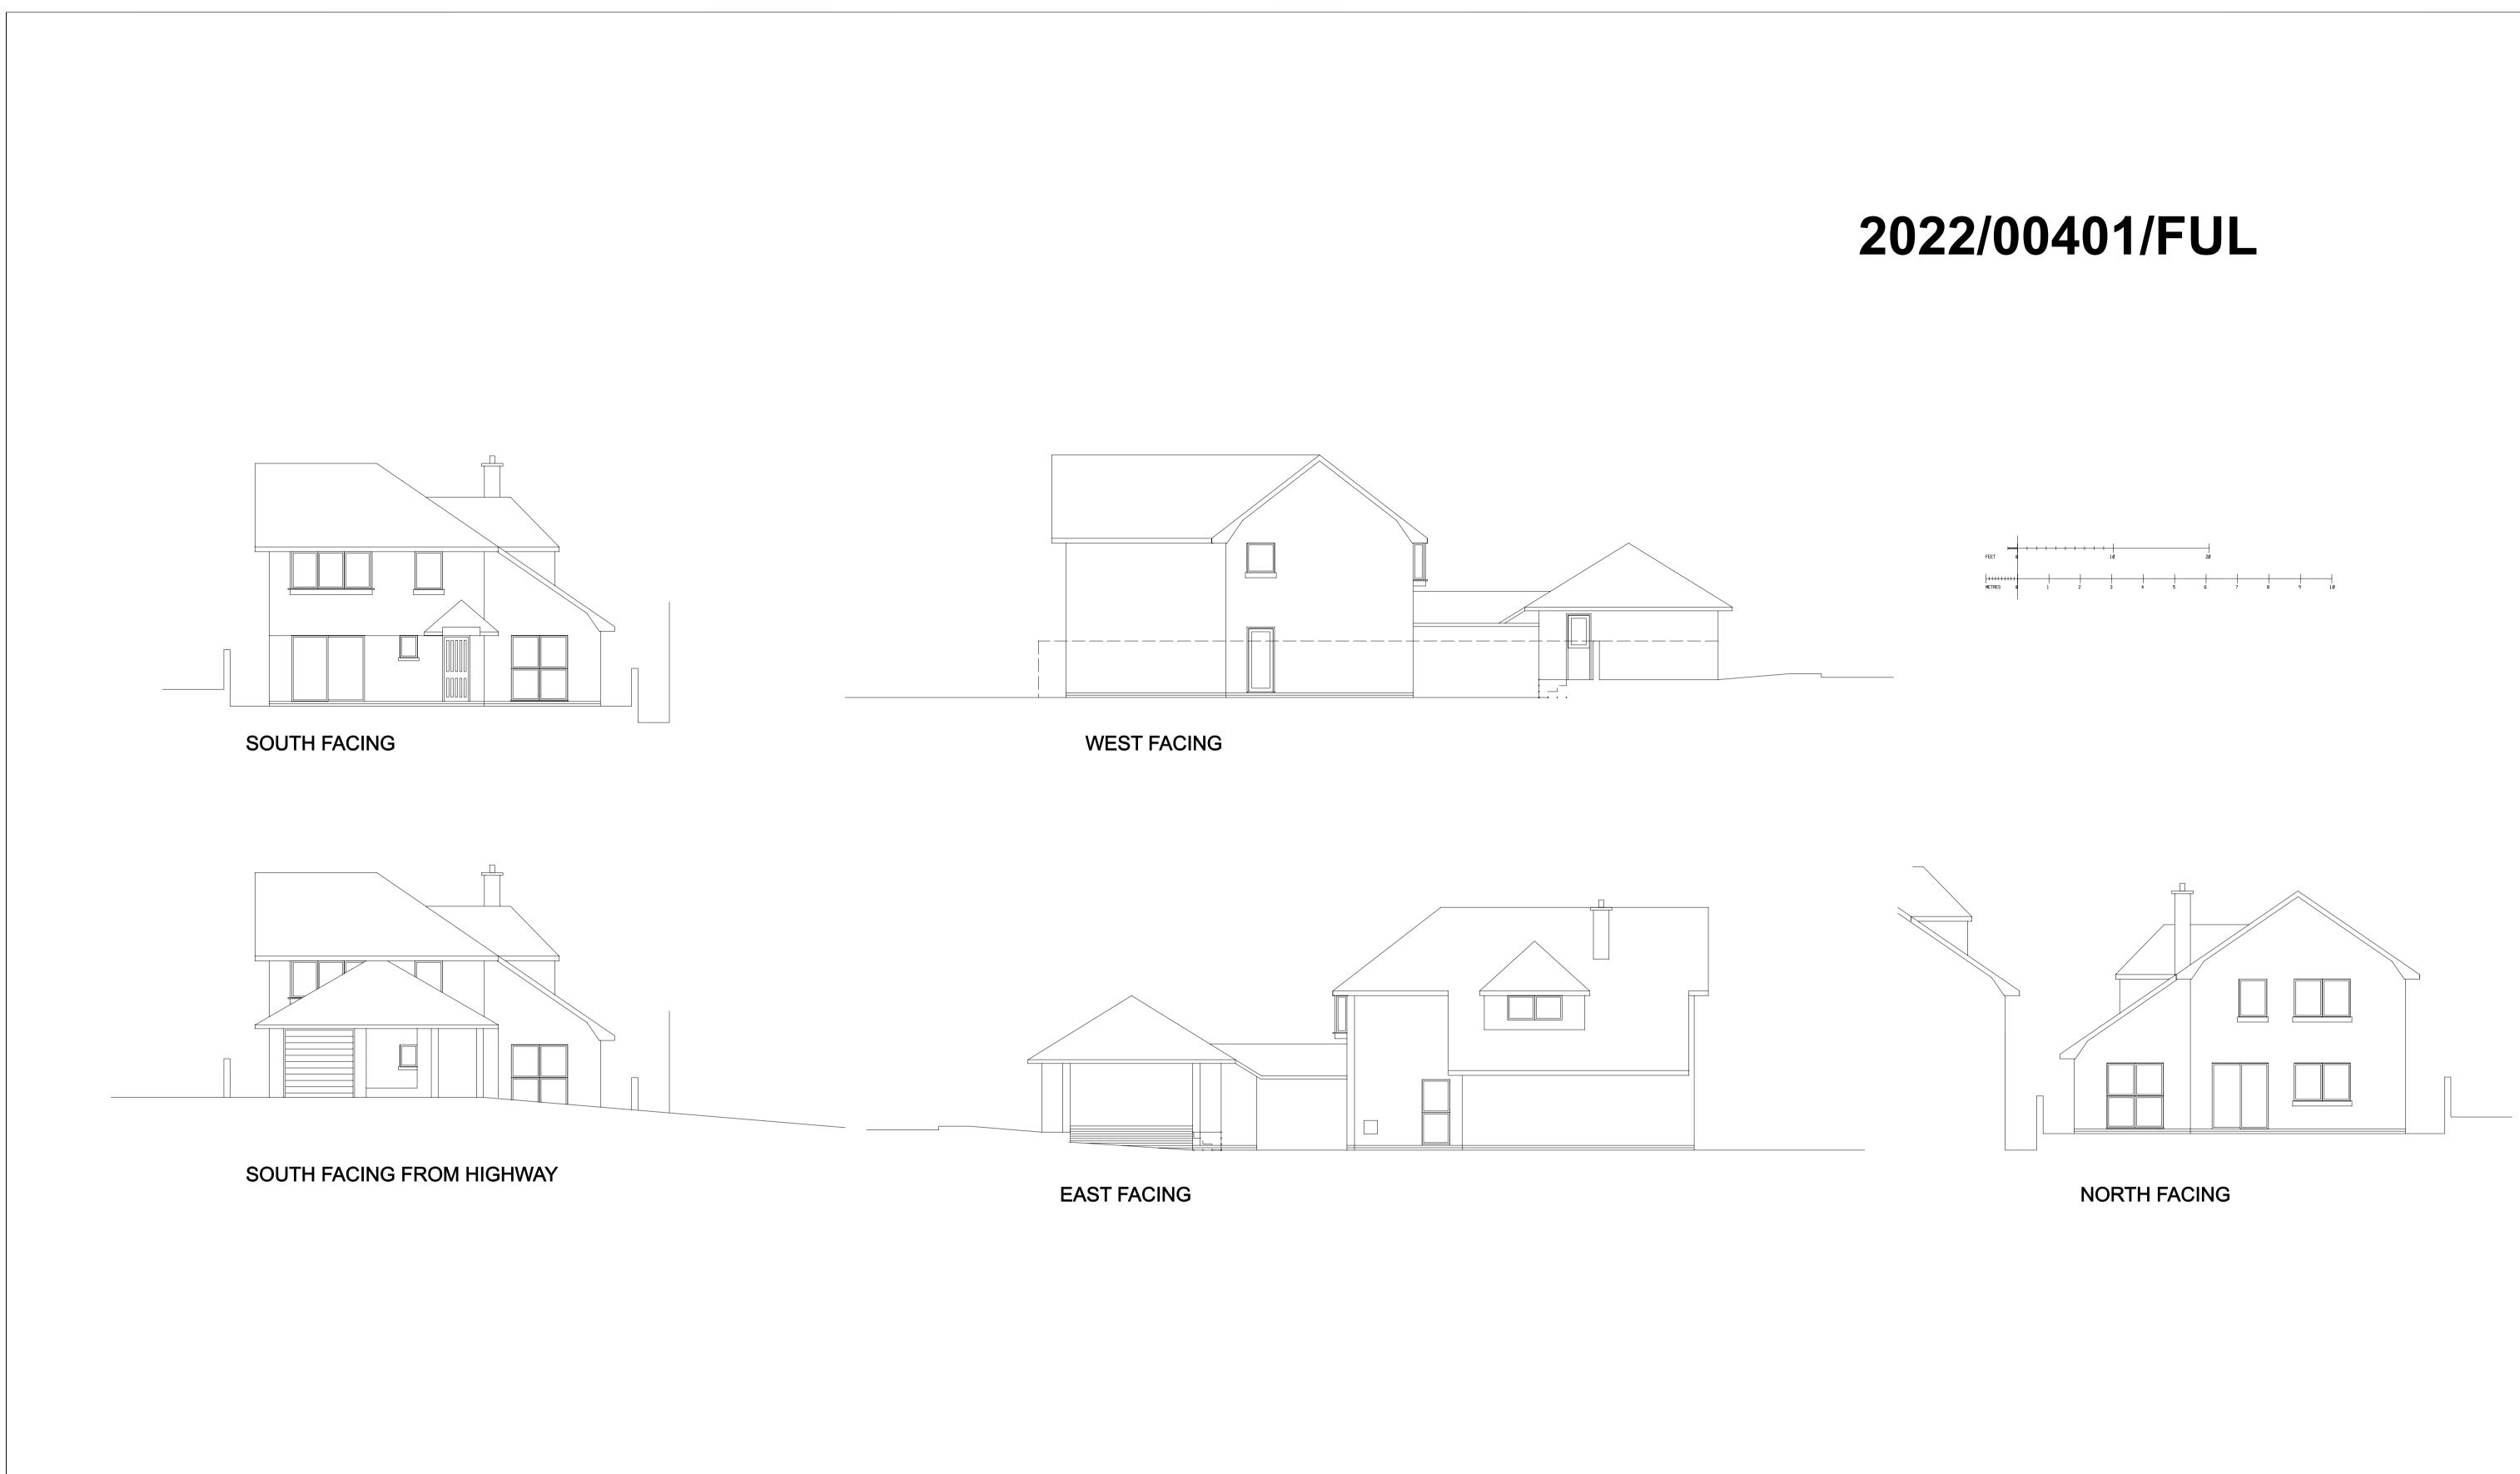

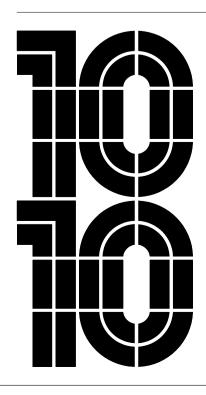


Notes:

Project : Single and two storey extensions, alterations and renovations

Client : Mr and Mrs Markos and Markella Asprou


PLANNING

1010 Architects. Studio 2 The Coach House, Stanwell Road Penarth, CF64 3EU email; info@1010architects.com tel. +44(0) 029 2071 0100

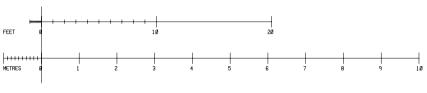


Job No	: 1010 0275 3 The Whi	te House, Barry	
Title	: Existing Elevations		
Drawing N	ío :EE 01		
Revision			
Revision			
Revision Scale	Date	Drawn	Checked


- Material Key:
 1 Slate tiles to match existing
 2. Hardwood timber windows and doors to match the existing, painted grey RAL 7023
 3. Timber frame window to match existing
 4. Blackened Larch vertical timber cladding
 5. Sectional door black.
 6. Timber facscia and soffit to match existing, painted black
 7. Black rainwater goods to match the existing
 8. Projecting window bay to replace the existing
 9. Conservation style window, obscure and non opening
 10. Smooth sand cement render painted white to match the existing
 11. Timber fence same height as the existing boundary wall to match cladding of main house
 12. Conservation style velux roof lights
 14. Sunpipe
 15. Obscure glazing as existing

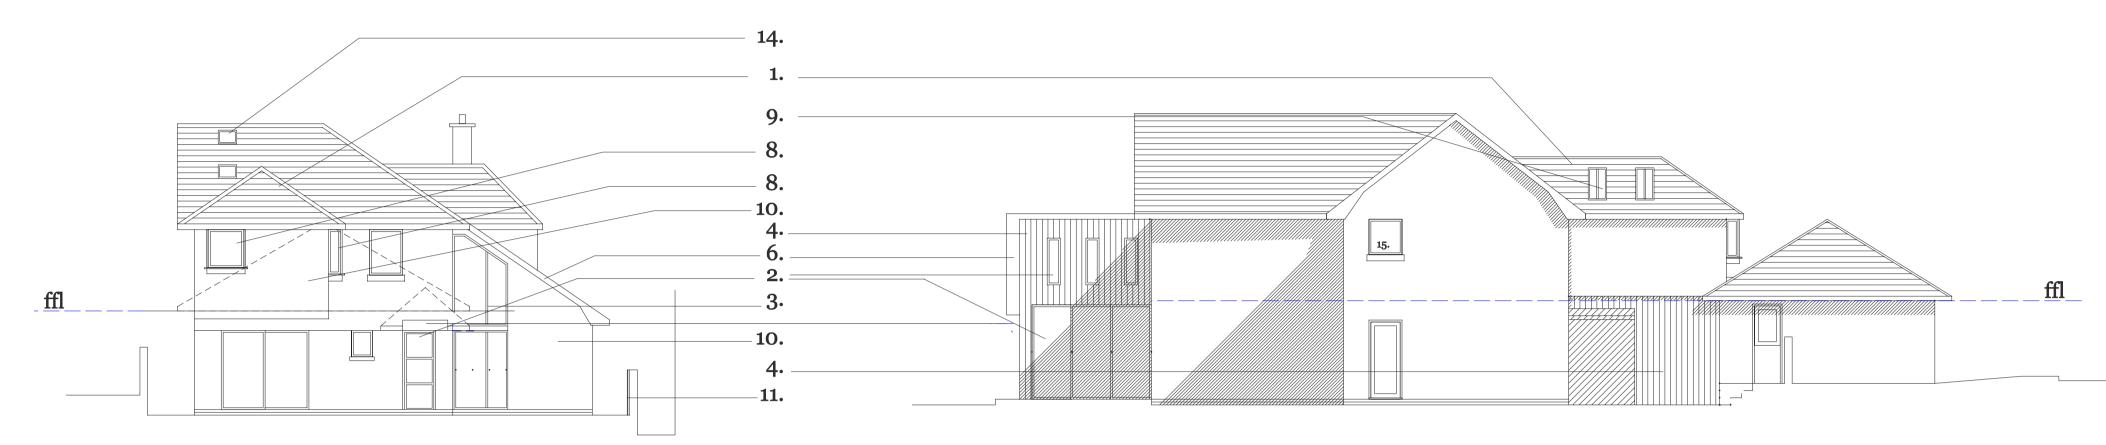



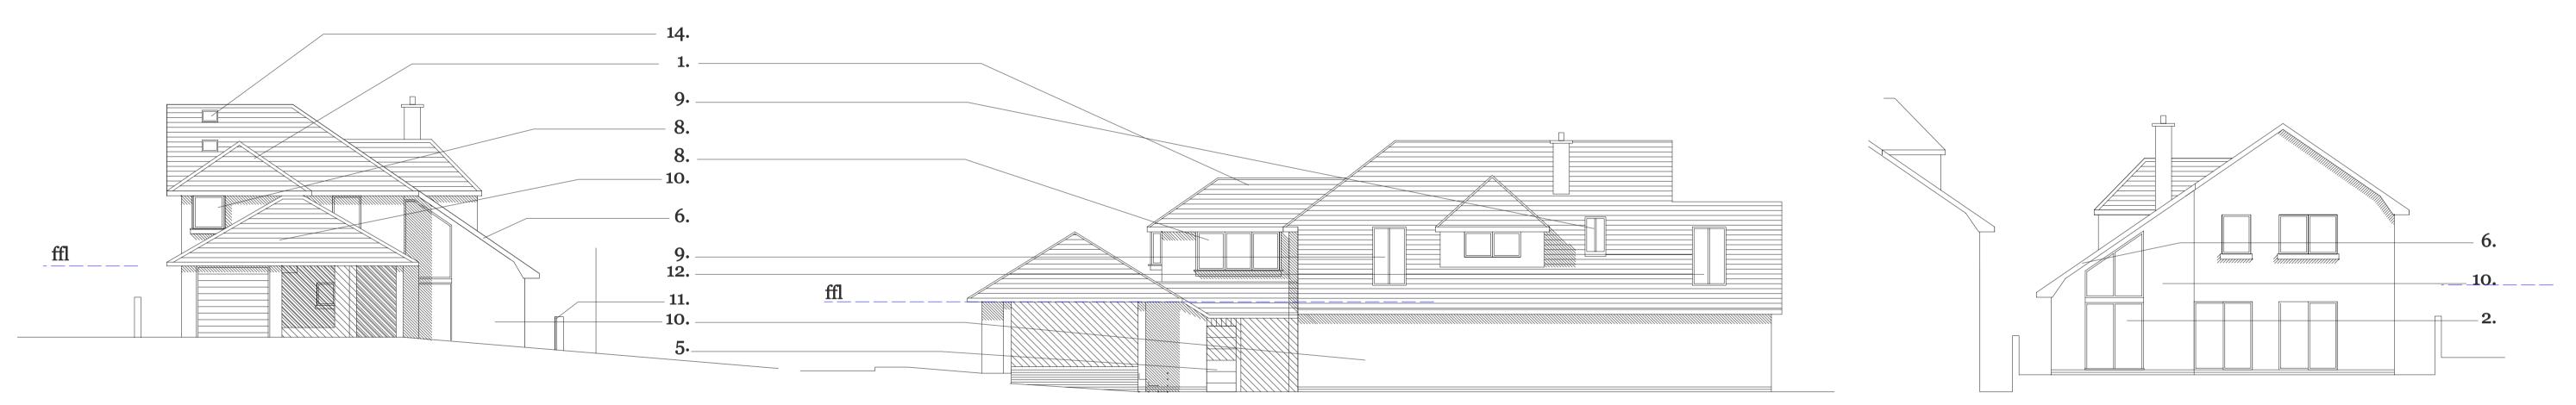

SOUTH FACING FROM HIGHWAY

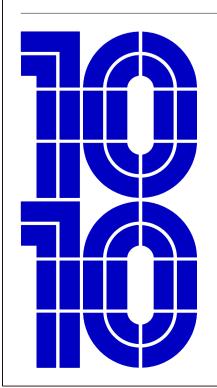

Notes:

Rev 1 - March 21 - Revisions and annotations made in accordance with lpa comments Rev 2- March 21 - Revisions and annotations made in accordance with lpa comments Rev 3 - April 21 - Aletrations to layout and design in order to reflect the co-habitation requirements for the proposed works.


Rev 4 - March 22 - Revised in accordance with planing inspectorate comments Rev 5 - May 22 - Revised in accordance with planing inspectorate comments



EAST FACING




2022/00401/FUL

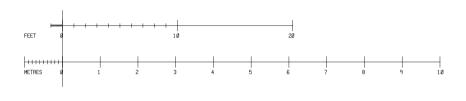

NORTH FACING

Job No	: 101	0 027	5 3 The	White	House,	Barry			
Title	: Pro	posed	Elevati	ons					
Drawing Revision		AE 01							_
1	2	3	4	5					
Scale 1:100 @ A	1		Date Jan 21		Dra CAI		-	Checked AA	
1:200 @A	3								

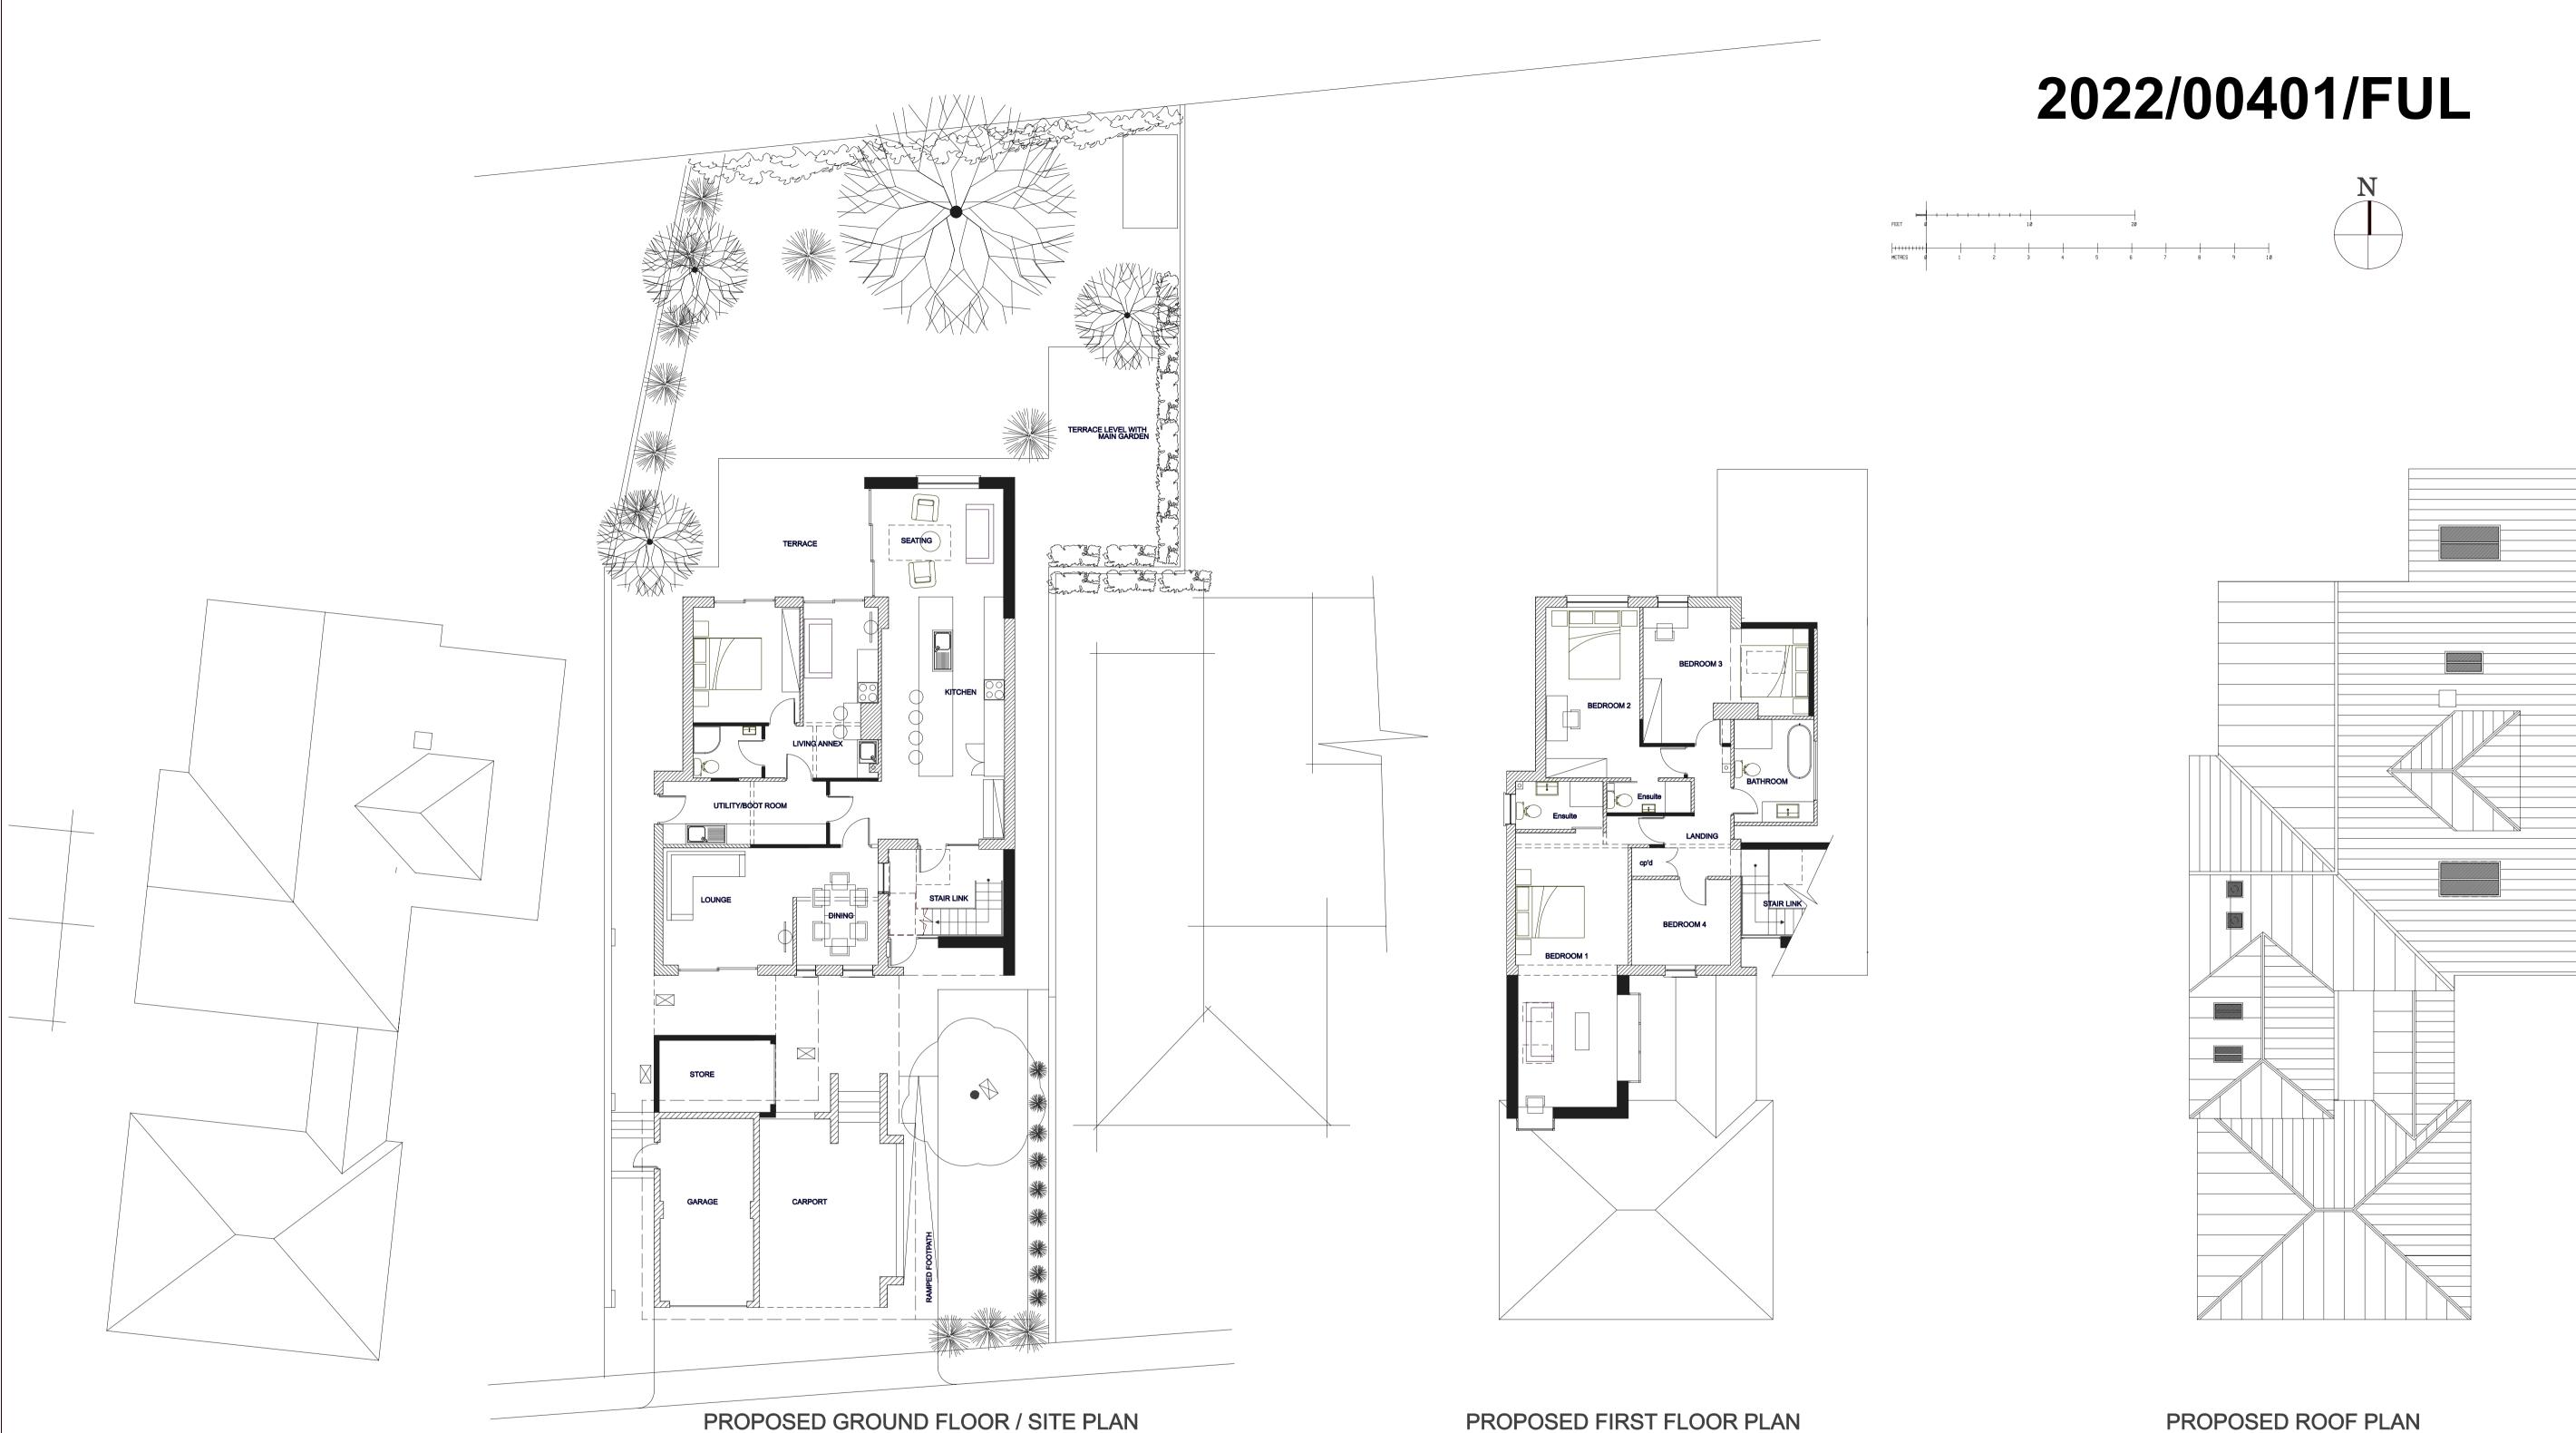



Rev 1 - March 21 - Revisions and annotations made in accordance with lpa comments Rev 2 - March 21 - Revisions and annotations made in accordance with lpa comments Rev 3 - April 21 - Aletrations to layout and design in order to reflect the co-habitation requirements for the proposed works. Rev 4 - March 22 - Revised in accordance with planning inspectorate comments

- Rev 5 May 22 Revised in accordance with planning inspectorate comments

PROPOSED FIRST FLOOR PLAN

Project : Single and two storey extensions, alterations and renovations incorporating annexed co-habitation at ground floor.


Client : Mr and Mrs Markos and Markella Asprou


PLANNING 1010 Architects. Studio 2

The Coach House, Stanwell Road Penarth, CF64 3EU tel. +44(0) 029 2071 0100 email; info@1010architects.com

PROPOSED ROOF PLAN

Job	No	: 10	10 027	5 3 The	White	House,	Barry		
Title	e	: Pro	oposed	l Floor F	Plans				
Dray	wing	No ·	AI 01						
	-	-	AL 01						
Rev	isior	1		4	5				
Rev	isior 1	-	AL 01	4 Date	5	Dra	wn	C	hecked

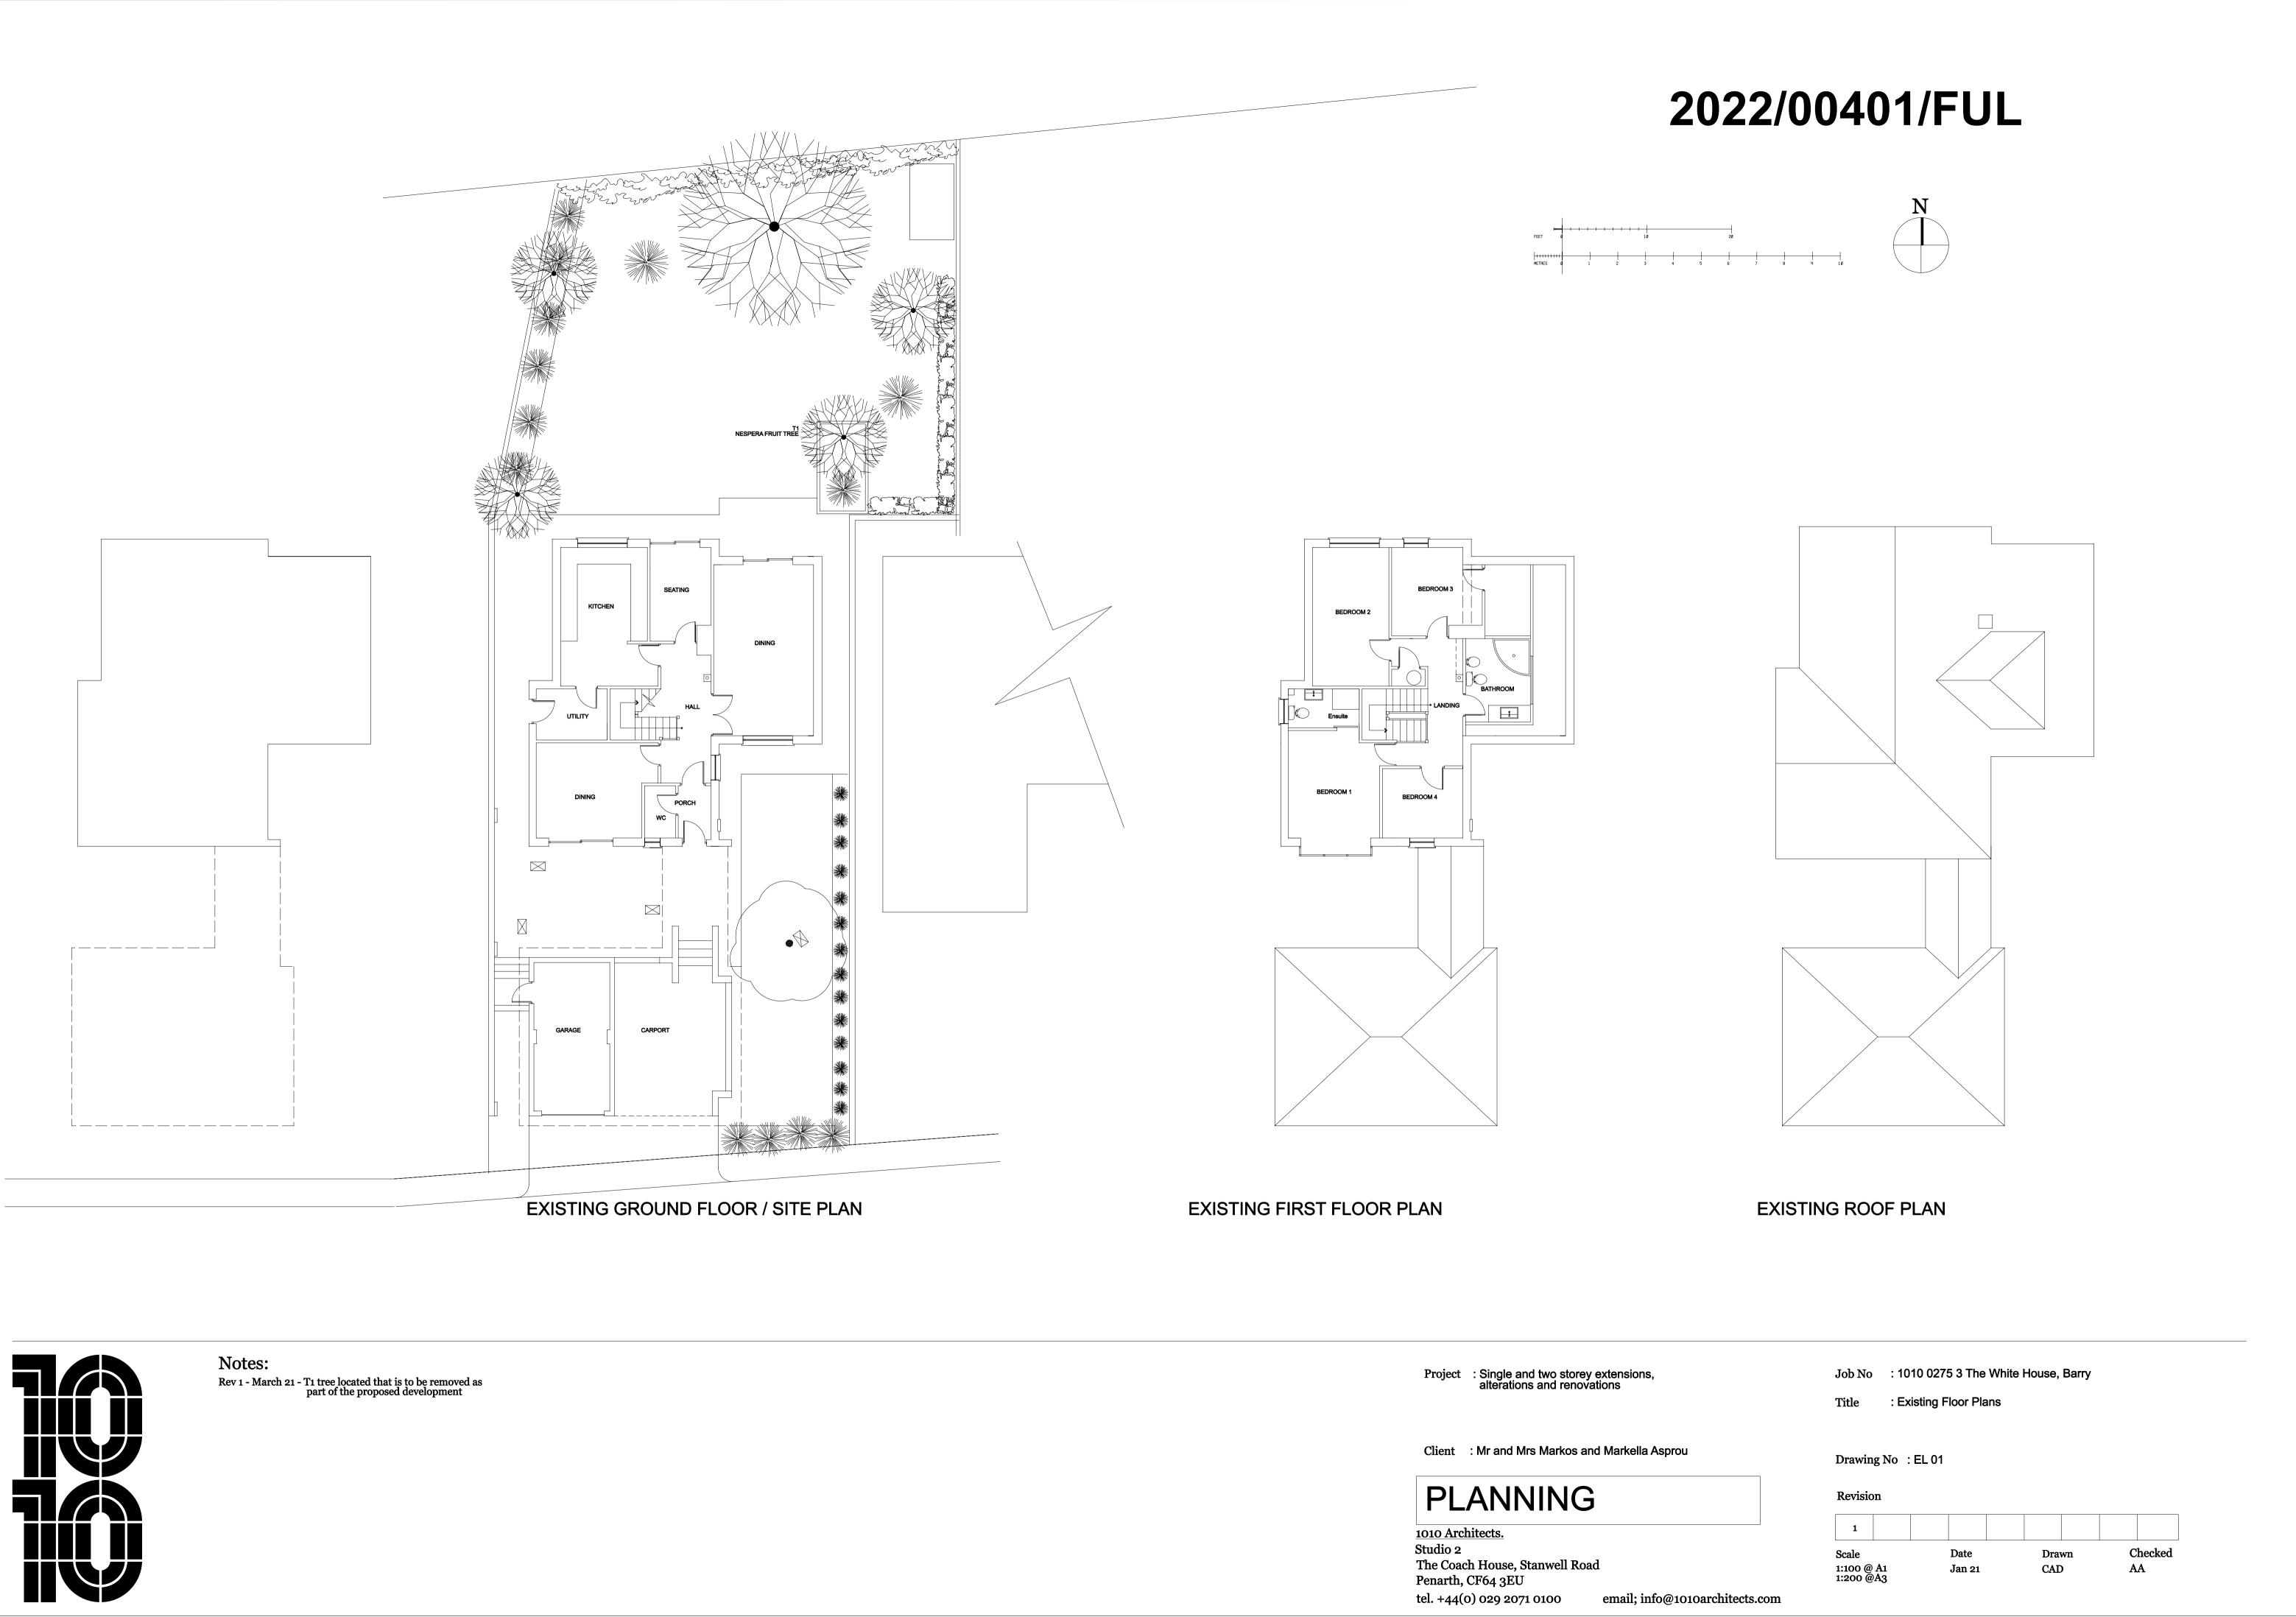

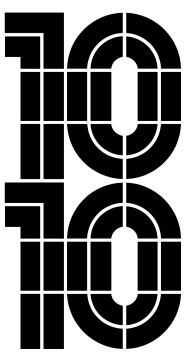



Penarth, CF64 3EU tel. +44(0) 029 2071 0100 email; info@1010architects.com

INTRODUCTION

The following report recognises the significance of the proposed sites context, located within the Barry Marine Conservation Area. Our report will set out the core Conservation Principles that have been observed and adhered to as part of our development proposals and design principles for the extensions and home improvements of 3 White House when considering the visual impact on the immediate context. In order that the impact of change to an are of aesthetic interest can be fully understood.

Our goal at 1010 architects is to make positive changes to the existing charm of the properties context with good design and the sensitive, considered use of materials that reflect and compliment the existing architectural vernacular.

THE SITE ASSET, CONTEXT and SIGNIFICANCE

Located within a cul-de-sac of similar type of houses, the property forms part of the of the initial phase of housing development that replaced a large and significant manor house and the surrounding grounds, that was known as The White House. The initial housing development constructed in the early to mid 1980's consists of thirteen separate four bedroom detached houses, of which there are three house types positioned sporadically around the site.

The design of The White House has a distinctive and consistent aesthetic across each house type, with use of material, style and colour. That are predominately white render, slate pitched roofs, dark frame timber windows, and black timber fascia, soffits and wall cladding. Design features of note, and consistent with the development are the projecting window bays and deep roof overhangs.

The site was subsequently developed further with a number of terraced properties to the eastern boundary of the site (known as the Fishermans Cottages) and larger detached bespoke single dwellings to the southern edge of the site. All of which have incorporated the design ethos of the original White Houses.







View of White House from street entrance via Cold Knap Way

Projecting window bay feature

Deep soffit Feature



1010 Architects; info@1010architects.com; tel: 029 20 710100 www.1010architects.com

January 2021

2022/00401/FUL

PROPOSED CHANGES

Our proposals to 3 White House seek planning permission for the single storey extensions to the eastern and northern parts of the house, and a two storey extension to the southern element of the house facing the street. For reasons of future sustainability, general home and living improvements concurrent with modern living standards.

DESIGN AND VISUAL IMPACT CONCLUSION

The design incorporates the existing pallet of materials and design features of the White Houses that are highlighted in this report, whilst respecting the scale and massing of the original structure.

The proposed extensions are sympathetic to the house that follow the existing roof pitches at single storey and are reduced in scale at two storey level in order to maintain the appreciation of the original house.

Our objective is to create an architectural scheme which reads well as a property, within its context and has the attributes that will visually enhance the environs of the conservation area and its immediate context.

MD2 Design of New Developments of the Vale of Glamorgan Local Development Plan 2011-2026 states that in order to create high quality, healthy, sustainable and locally distinct places development proposals should:

1. Be of a high standard of design that positively contributes to the context and character of the surrounding natural and built environment and protects existing features of townscape or landscape interest.

2. Respond appropriately to the local context and character of neighbouring buildings and uses in terms of use, type, form, scale, mix and density. Policy MD5 Development within Settlement Boundaries states that new development within settlements will be permitted where the proposed development;

1. Makes efficient use of land or buildings

2. Is of a scale, form, layout and character that is sympathetic to and respects its immediate setting and the wider surroundings and does not unacceptably impact upon the character and appearance of the locality

3. The proposal would not result in the loss of natural or built features that individually or cumulatively contribute to the character of the settlement or its setting.





1010 Architects; info@1010architects.com; tel: 029 20 710100 www.1010architects.com

January 2021


2022/00401/FUL




Site Picture 1: Applicants' property taken from the rear garden facing the rear of the property.




Site Picture 2: Eastern Boundary with number 5 White House.

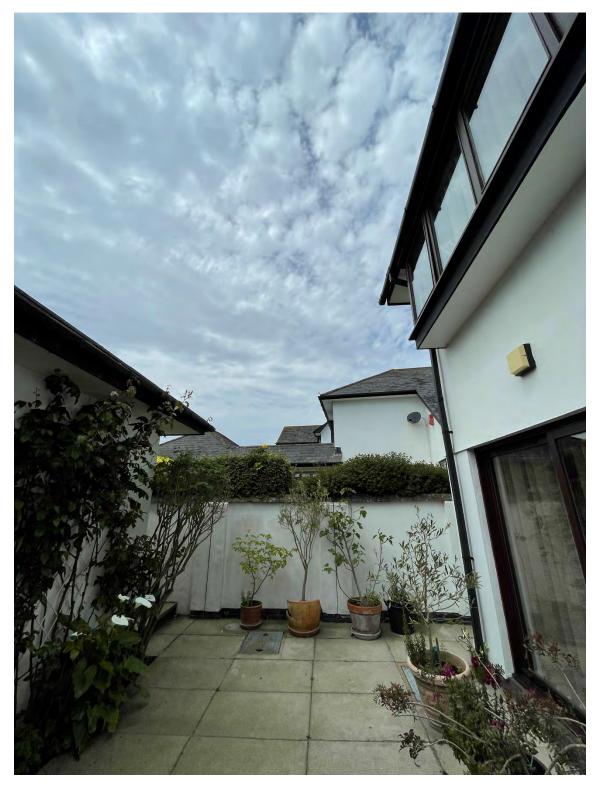


Site Picture 3: Front courtyard area facing the western boundary towards number 1 White House.

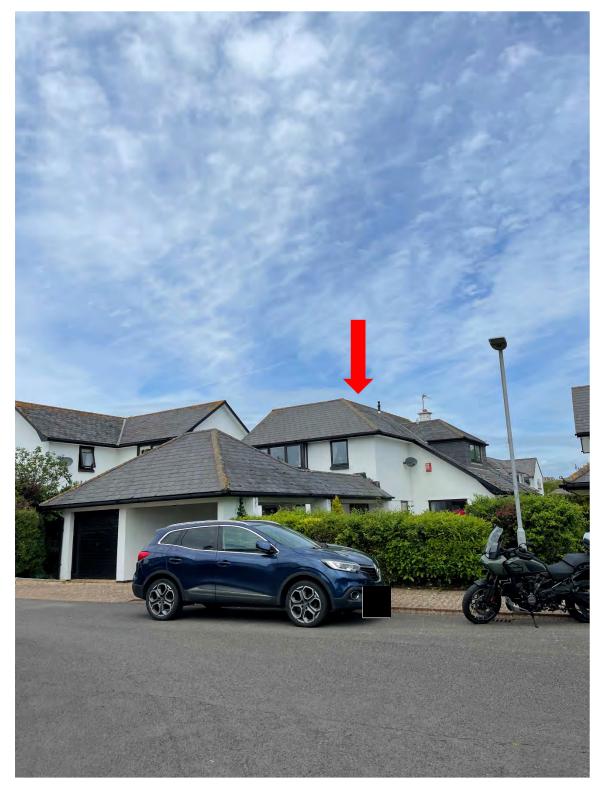

Site Picture 4: View of the application property (arrowed in red) from the street scene.

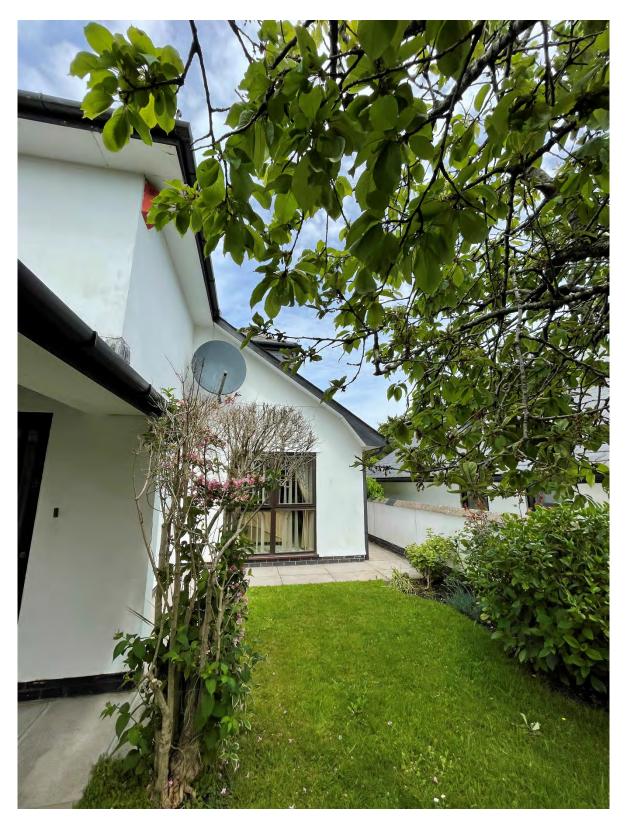

Site Picture 4: View from applicants' front garden facing the front/side elevation of property.

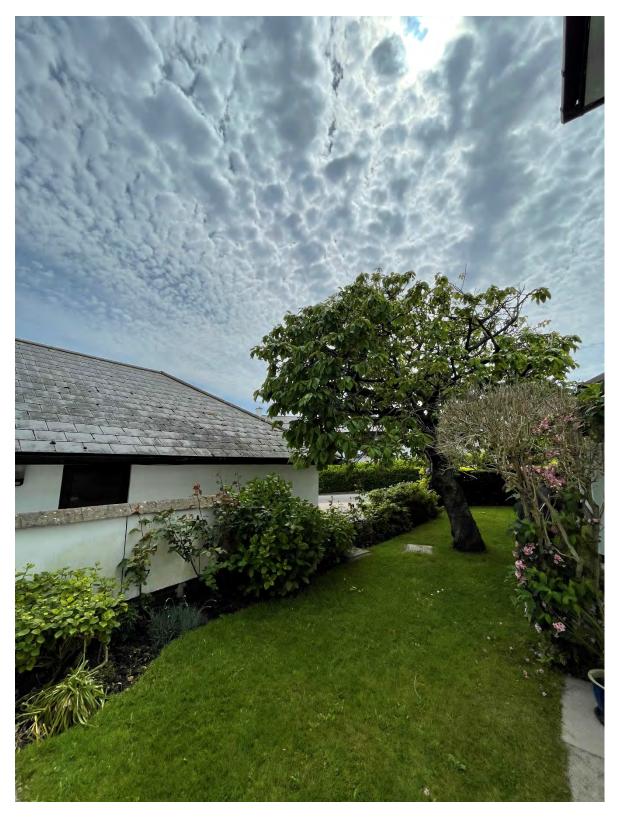


Site Picture 5: View from applicants' property facing south-east towards the streetscene and neighbouring property; 5 White House.



Site Picture 6: Picture from applicants' property eastwards facing neighbouring property -5 White House.



Site Picture 7: Boundary from the front elevation of the applicants' property and neighbouring property number 5 White House.

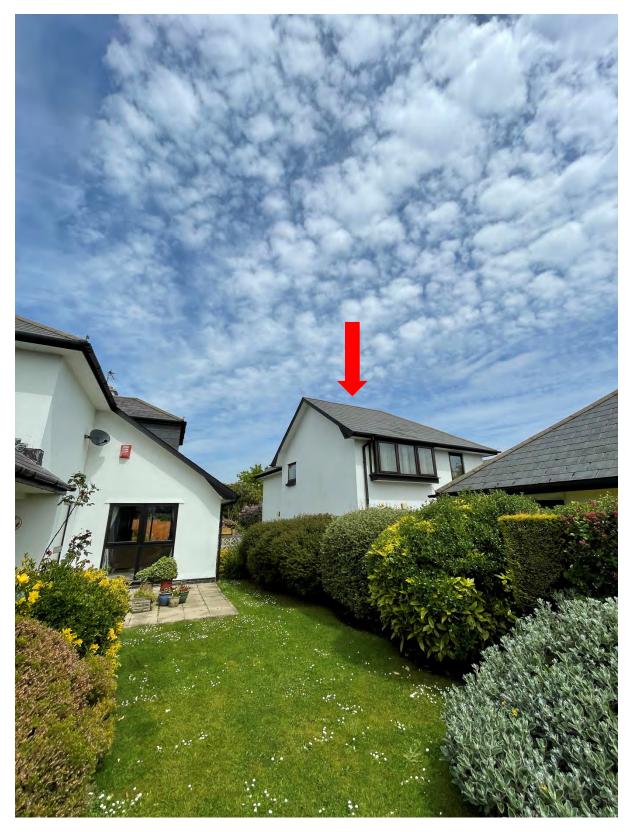

Site Picture 8: Outlook of the front elevation of the applicants' property (marked in red) from front garden of neighbouring property -1 White House.



Site Picture 9: Outlook of the applicants' property from front/side garden at neighbouring property – 1 White House.